

Jamestown S'Klallam Tribe Topographic Survey


located in Section 19, Township 30 North, Range 3 West, W.M.
Clallam County, Washington
July, 2019

LEGEND

-  05/03/2019, FOUND 5/8-INCH REBAR WITH CAP "CLALLAM PUD PLS 23603" AT N88°17'10.60". SEE DNR PERMIT TO DESTROY MONUMENT NO. 5720
 -  MAY 2-7, 2019, FOUND 1/2-INCH REBAR WITH PLASTIC CAP STAMPED "DC&A LS 22329" OR "CUMMINS LS 22329" PER SURVEYS LISTED HEREON
 -  MAY 7, 2019, FOUND 5/8-INCH REBAR WITH PLASTIC CAP STAMPED "CLARK 12223" PER BOOK 13 OF PLATS, PAGES 20-21
 -  MAY 2, 2019, FOUND 3/8-INCH REBAR IN PAVEMENT
 -  CLALLAM COUNTY AUDITOR'S FILE NUMBER OF RECORD LEGAL DESCRIPTION
 -  HIGHWAY ENGINEERS STATION
 -  BARBED WIRE FENCE, U.N.O.
 -  EDGE OF PAVEMENT
 -  OPEN DITCH
- DATUM**
- HORIZONTAL**
- NORTH AMERICAN DATUM OF 1983, 1991 ADJUSTMENT, NAD 83(91)
- VERTICAL**
- NORTH AMERICAN VERTICAL DATUM OF 1988, NAVD 88
- SITE BENCHMARKS AS NOTED

NOTES

1. THIS SURVEY USES THE SECTION SUBDIVISION AS SHOWN ON BOOK 61 OF SURVEYS, PAGE 13 AND BOOK 39 OF SURVEYS, PAGE 86 AND IS BASED ON THE WASHINGTON COORDINATE SYSTEM GRID, NORTH ZONE, NAD 83(91) PER TIES TO GEOMPT NUMBERS 03301931, 03303021 AND 04302441. ALL BEARINGS ARE RELATIVE TO SAID GRID. ALL DISTANCES ARE REDUCED TO SAID GRID USING A COMBINED SCALE FACTOR OF 0.9999328. TO OBTAIN GROUND DISTANCES, MULTIPLY DISTANCES SHOWN HEREON BY 1.0000672.
2. FOR LEGAL DESCRIPTION AND EASEMENTS, SEE AFN 2019-1379179 AND OLD REPUBLIC TITLE REPORT ORDER NO. 114860-DF, DATED 03/26/2019.
3. THIS SURVEY COMPLIES WITH W.A.C. 332-130-100 AND WAS ACCOMPLISHED IN MAY-JULY, 2019 BY FIELD TRAVERSE METHODS USING A TOPCON GPT 9001A 1-SECOND ROBOTIC TOTAL STATION CALIBRATED AT THE CLALLAM COUNTY BASELINE ON SEPTEMBER 17, 2015. SOME DISTANCES MEASURED WITH A STEEL TAPE.
4. THIS SURVEY WAS PERFORMED ACCORDING TO W.A.C. 332-130-090 STANDARDS FOR LAND BOUNDARY SURVEYS. THIS SURVEY WAS NOT PERFORMED OR CERTIFIED TO MEET THE CURRENT "MINIMUM STANDARD DETAIL REQUIREMENTS" OR "ACCURACY STANDARDS" FOR ALTA/ACSM LAND TITLE SURVEYS. THEREFORE, USE OF THIS MAP FOR THE ISSUANCE OF AN ALTA/ACSM OWNER'S EXTENDED COVERAGE POLICY IS STRICTLY PROHIBITED.
5. THE SURVEYED PARCEL MAY BE SUBJECT TO EASEMENTS OR OTHER ENCUMBRANCES EITHER RECORDED OR UNRECORDED NOT SHOWN HEREON. THIS SURVEY HAS NOT DETERMINED THE EXISTENCE OF ALL SUCH EASEMENTS OR ENCUMBRANCES OR THEIR EFFECT ON THE SURVEYED PARCEL EXCEPT AS SPECIFICALLY SHOWN HEREON.
6. THE UTILITIES SHOWN HEREON ARE BASED ON AND UTILITY LOCATE NO. 19320557 AND ABOVE GROUND OBSERVATIONS. THESE LOCATIONS SHOULD BE CONSIDERED APPROXIMATE AND POSSIBLY INCOMPLETE.

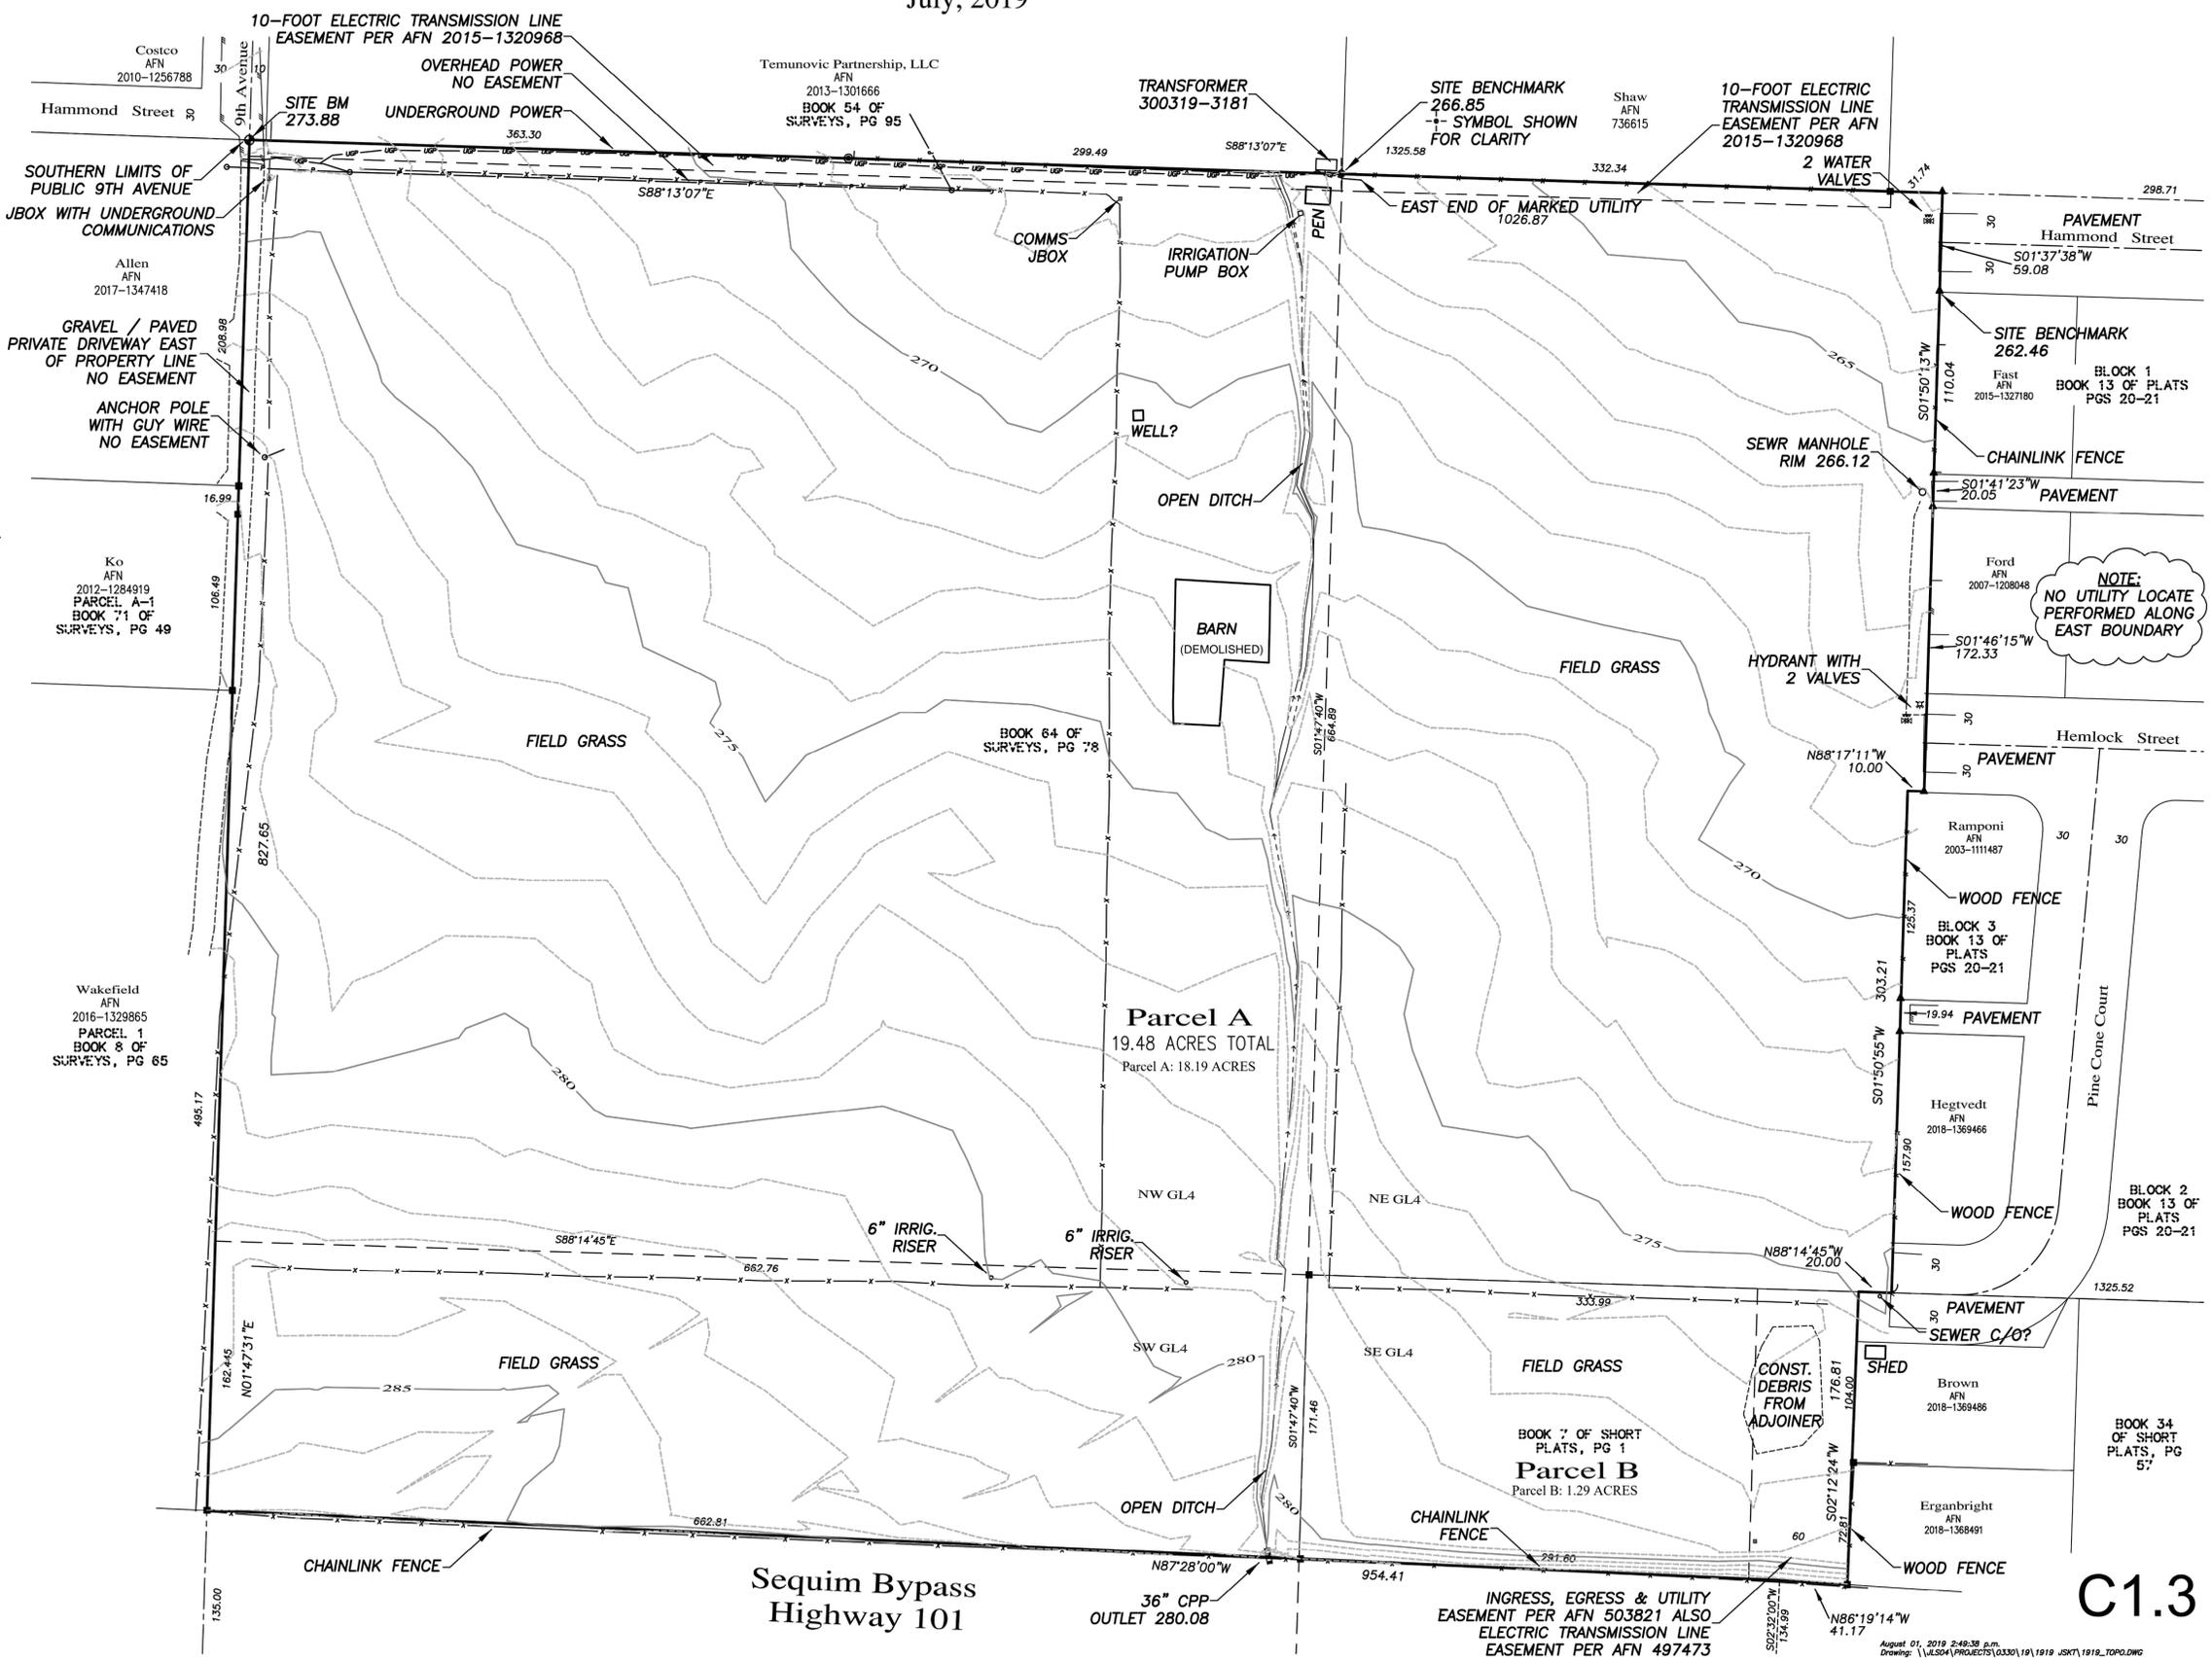

C1.3

540 W. Eighth Street, Port Angeles, WA 98362
360.452.0237 office, 360.452.0238 fax
www.johnstonlandsurveying.com

JOHNSTON
Land Surveying



A SURVEY IN GOVERNMENT LOT 4, SECTION 19
TOWNSHIP 30 NORTH, RANGE 4 WEST, W.M.
CLALLAM COUNTY, WASHINGTON

Former "Dawley Property"
Proposed MAT Facility
Topographic Survey, July 2019

I HEREBY CERTIFY THAT I AM A PROFESSIONAL LAND SURVEYOR LICENSED TO PRACTICE IN THE STATE OF WASHINGTON AND DECLARE THAT THIS MAP CORRECTLY REPRESENTS A SURVEY PERFORMED UNDER MY SUPERVISION AT THE REQUEST OF THE JAMESTOWN S'KLALLAM TRIBE IN MAY, 2019.

Rob Johnston
PLS. 37531

DATE: 1/30/2018
SCALE: 1"=50'
DRAWN BY: RRU
PLAT CHECKED BY: RRU
SHEET 1 OF 1


August 01, 2019 2:48:38 P.M.
Drawing: \\1204\PROJETS\0330\19\1919 JSKT\1919_Topo.DWG




MATCH LINE - SEE THIS SHEET

LEGEND

- GRAVEL CONSTRUCTION ENTRANCE
- EXISTING ASPHALT TO BE REMOVED
- EXISTING GRAVEL TO BE REMOVED
- CONSTRUCTION LIMITS
- SILT FENCE
- TEMPORARY DRAINAGE SWALE
- EXISTING TREES TO REMAIN
- EXISTING TREES TO BE REMOVED
- PROTECT EXISTING TREES
- EXISTING FENCE
- SAWCUT
- HIGH VISIBILITY FENCE
- INLET PROTECTION

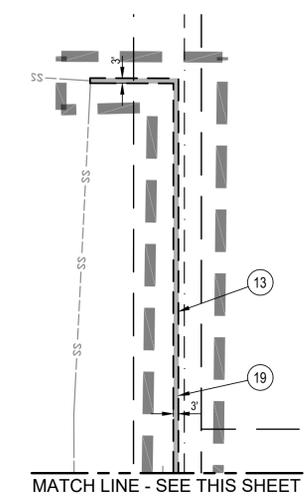

MATCH LINE - SEE THIS SHEET

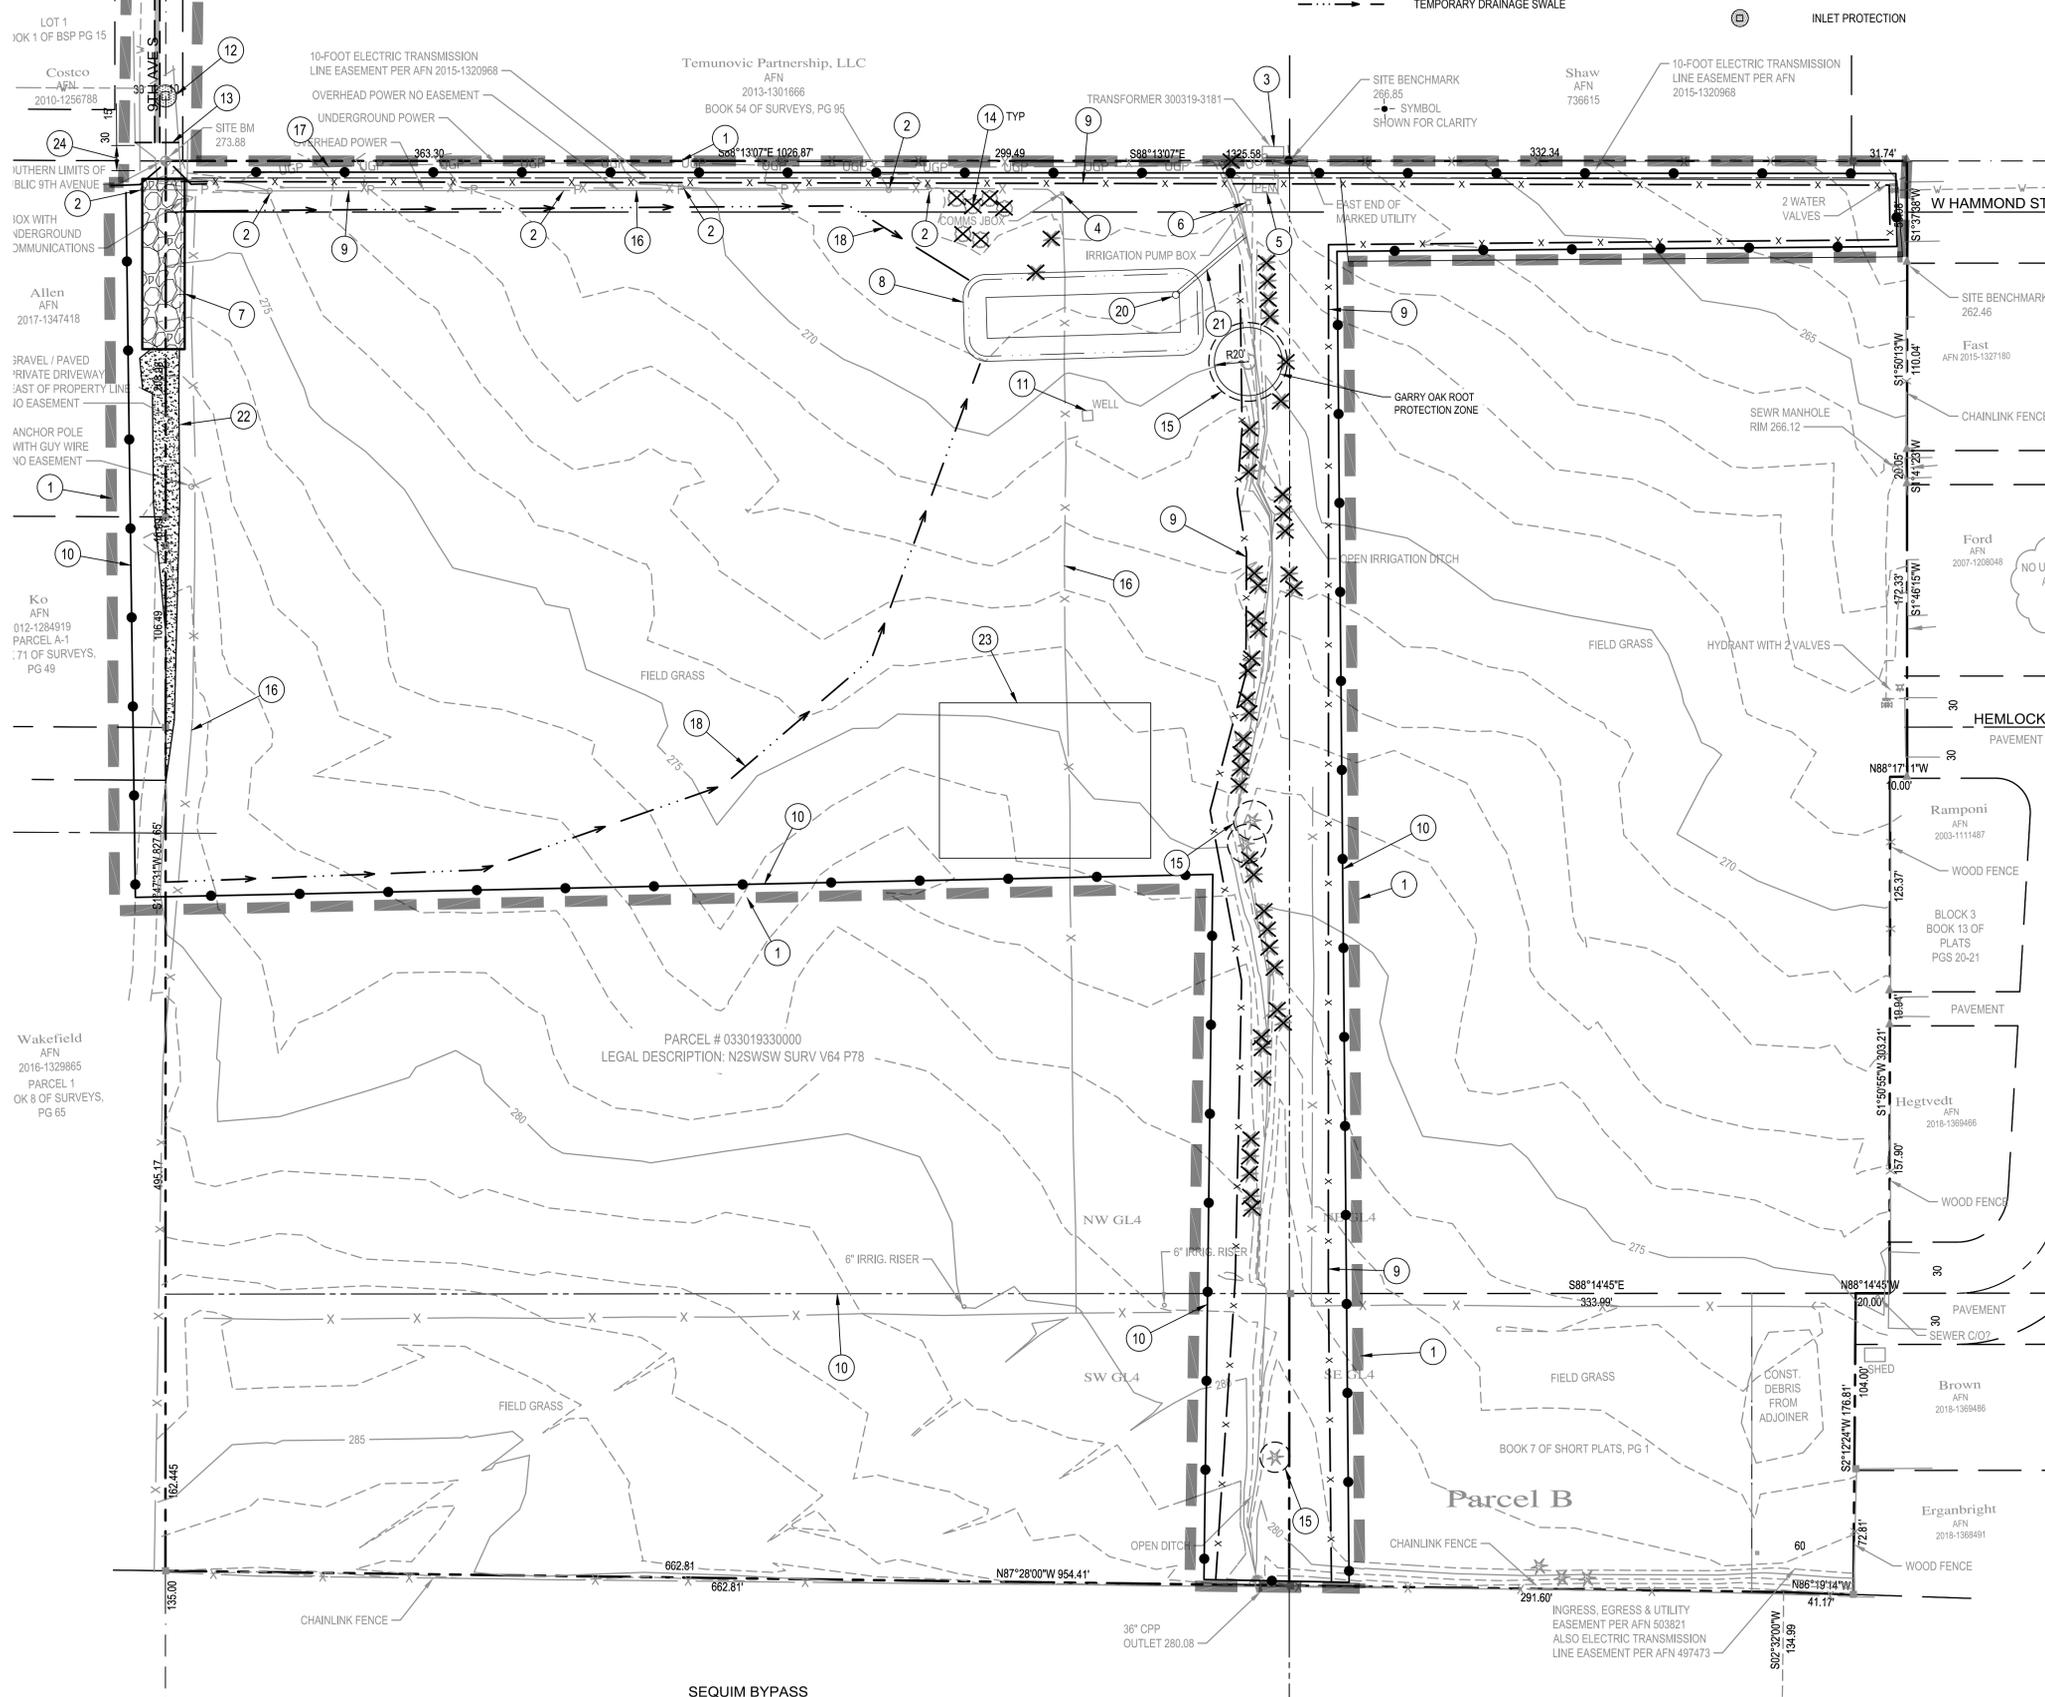

DEMOLITION & TESC NOTES

- 1 LIMITS OF CONSTRUCTION
- 2 POWER SERVICE TO BE RELOCATED PER UTILITY PURVEYOR, IN PROGRESS
- 3 PROTECT TRANSFORMER DURING CONSTRUCTION
- 4 RELOCATE COMMUNICATION PER ELECTRICAL
- 5 REMOVE LEAN-TO
- 6 REMOVE IRRIGATION PUMP
- 7 INSTALL CONSTRUCTION ENTRANCE PER DETAIL 2, SHEET C2.1
- 8 INSTALL SEDIMENT POND WITH LINER FOR CONSTRUCTION
- 9 INSTALL FILTER FABRIC FENCE PER DETAIL 5, SHEET C2.1
- 10 INSTALL HIGH VISIBILITY FENCE PER WSDOT STD PLAN I-10.10-01
- 11 DECOMMISSION WELL PER WASHINGTON STATE DEPARTMENT OF ECOLOGY STANDARDS AND REMOVE ALL WATER FITTINGS AND PIPES
- 12 INSTALL INLET PROTECTION PER DETAIL 1, SHEET C2.1
- 13 SAWCUT
- 14 REMOVE EXISTING TREE
- 15 PROTECT EXISTING TREE PER DETAIL 9, SHEET C2.1
- 16 REMOVE EXISTING FENCE
- 17 PROTECT UNDERGROUND POWER
- 18 INSTALL TEMPORARY SWALE PER DETAIL 6, SHEET C2.1
- 19 REMOVE EXISTING ASPHALT
- 20 TESC POND STANDPIPE PER DETAIL 8, SHEET C2.1
- 21 INSTALL 52 LF 12" CMP OUTFALL PIPE
- 22 REMOVE GRAVEL DRIVE AS NEEDED
- 23 STOCKPILE PER DETAIL 4, SHEET C2.1
- 24 DEMO 15 LF EXISTING WATER LINE

JAMESTOWN S'KLALLAM TRIBE
OUTPATIENT CLINIC
SEQUIM, WASHINGTON

FOR PLAN CHECK REVIEW

REV	DATE	DESCRIPTION

PROJ. NO.	191652
DRAWN	KB
CHECKED	ALH
DATE	JAN 10, 2020


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SHEET TITLE:
DEMOLITION AND TESC PLAN

SHEET NO:

C2.0

SHEET OF

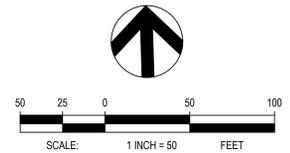


SEQUIM BYPASS

INGRESS, EGRESS & UTILITY EASEMENT PER AFN 503821 ALSO ELECTRIC TRANSMISSION LINE EASEMENT PER AFN 497473



LEGEND

- XX--- EXISTING CONTOUR
- XXX--- PROPOSED CONTOUR
- XX.XX FINISH GROUND ELEVATION
- ← 2.8% FLOW DIRECTION WITH GRADE
- GRADE BREAK

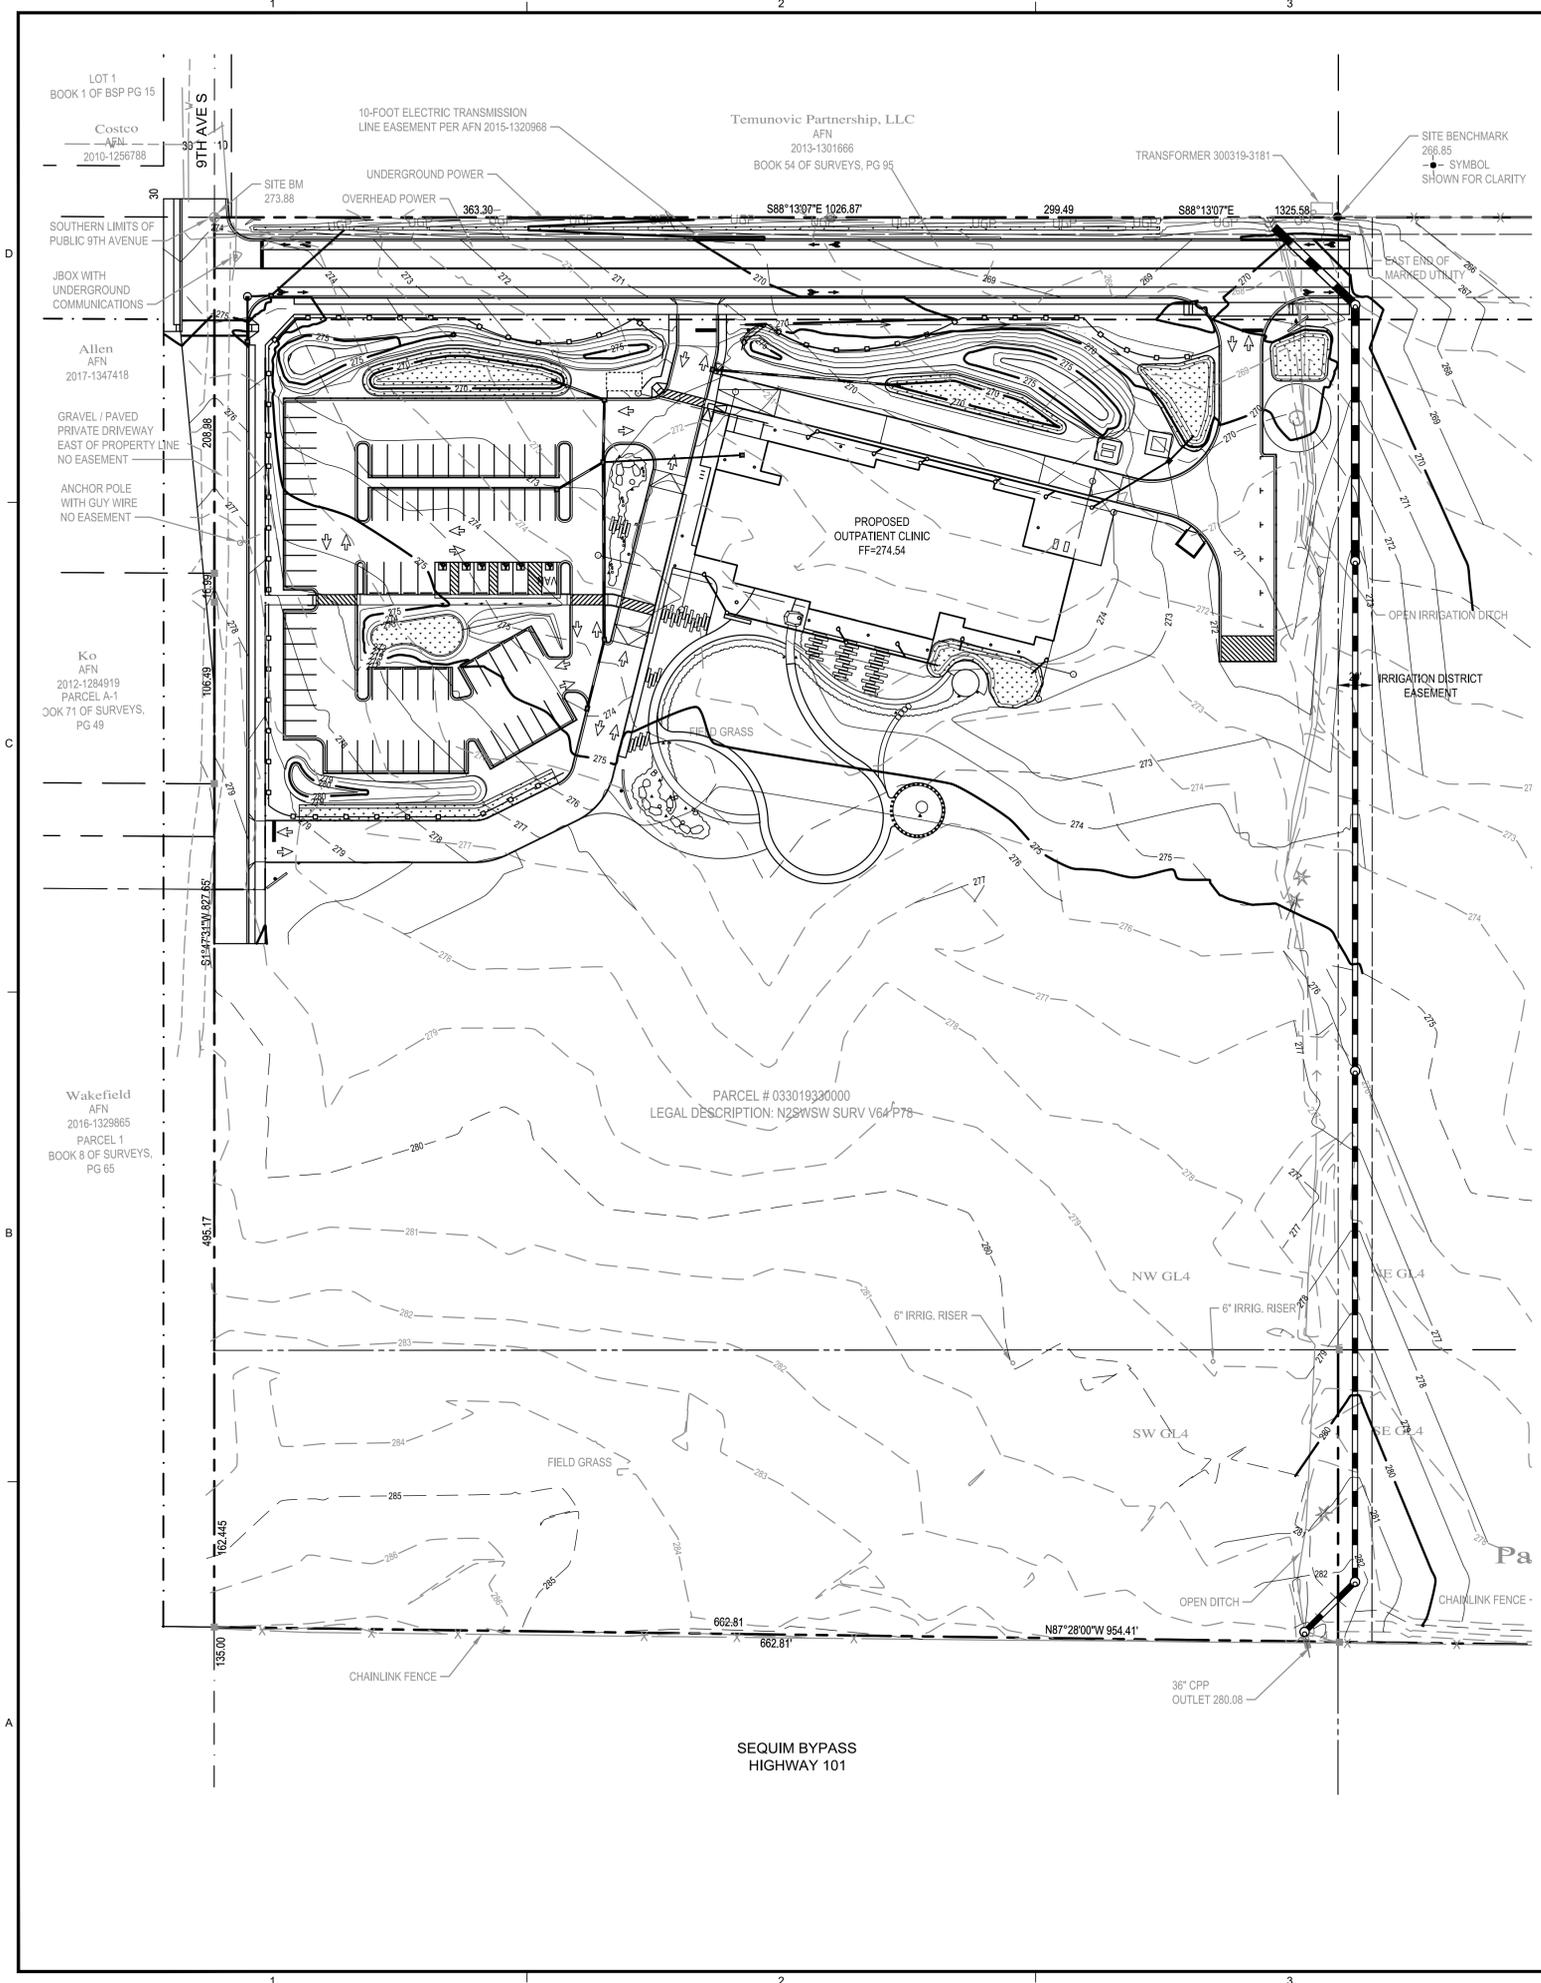

**JAMESTOWN S'KLALLAM TRIBE
OUTPATIENT CLINIC
SEQUIM, WASHINGTON**

FOR PLAN CHECK REVIEW

REV	DATE	DESCRIPTION

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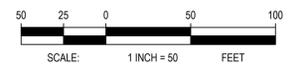
SHEET TITLE:

OVERALL GRADING AND STORMWATER DRAINAGE PLAN

SHEET NO:

C3.0

SHEET OF






LEGEND

- XX--- EXISTING CONTOUR
- XXX--- PROPOSED CONTOUR
- XX.XX FINISH GROUND ELEVATION
- 2.8% FLOW DIRECTION WITH GRADE
- GRADE BREAK

GRADING NOTES

- 1 BEGIN 6" CURB
- 2 TRANSITION FROM 6" CURB TO FLUSH CURB
- 3 BEGIN FLUSH CURB
- 4 SIDEWALK FLUSH WITH PAVEMENT
- 5 MATCH EXISTING GRADE
- 6 SWALE
- 7 BERM, PER LANDSCAPE ARCHITECT'S PLANS
- 8 STORM SYSTEM, REFER TO C5.1 & C5.2
- 9 HAND GRADING ONLY WITHIN DRIPLINE OF EXISTING TREE

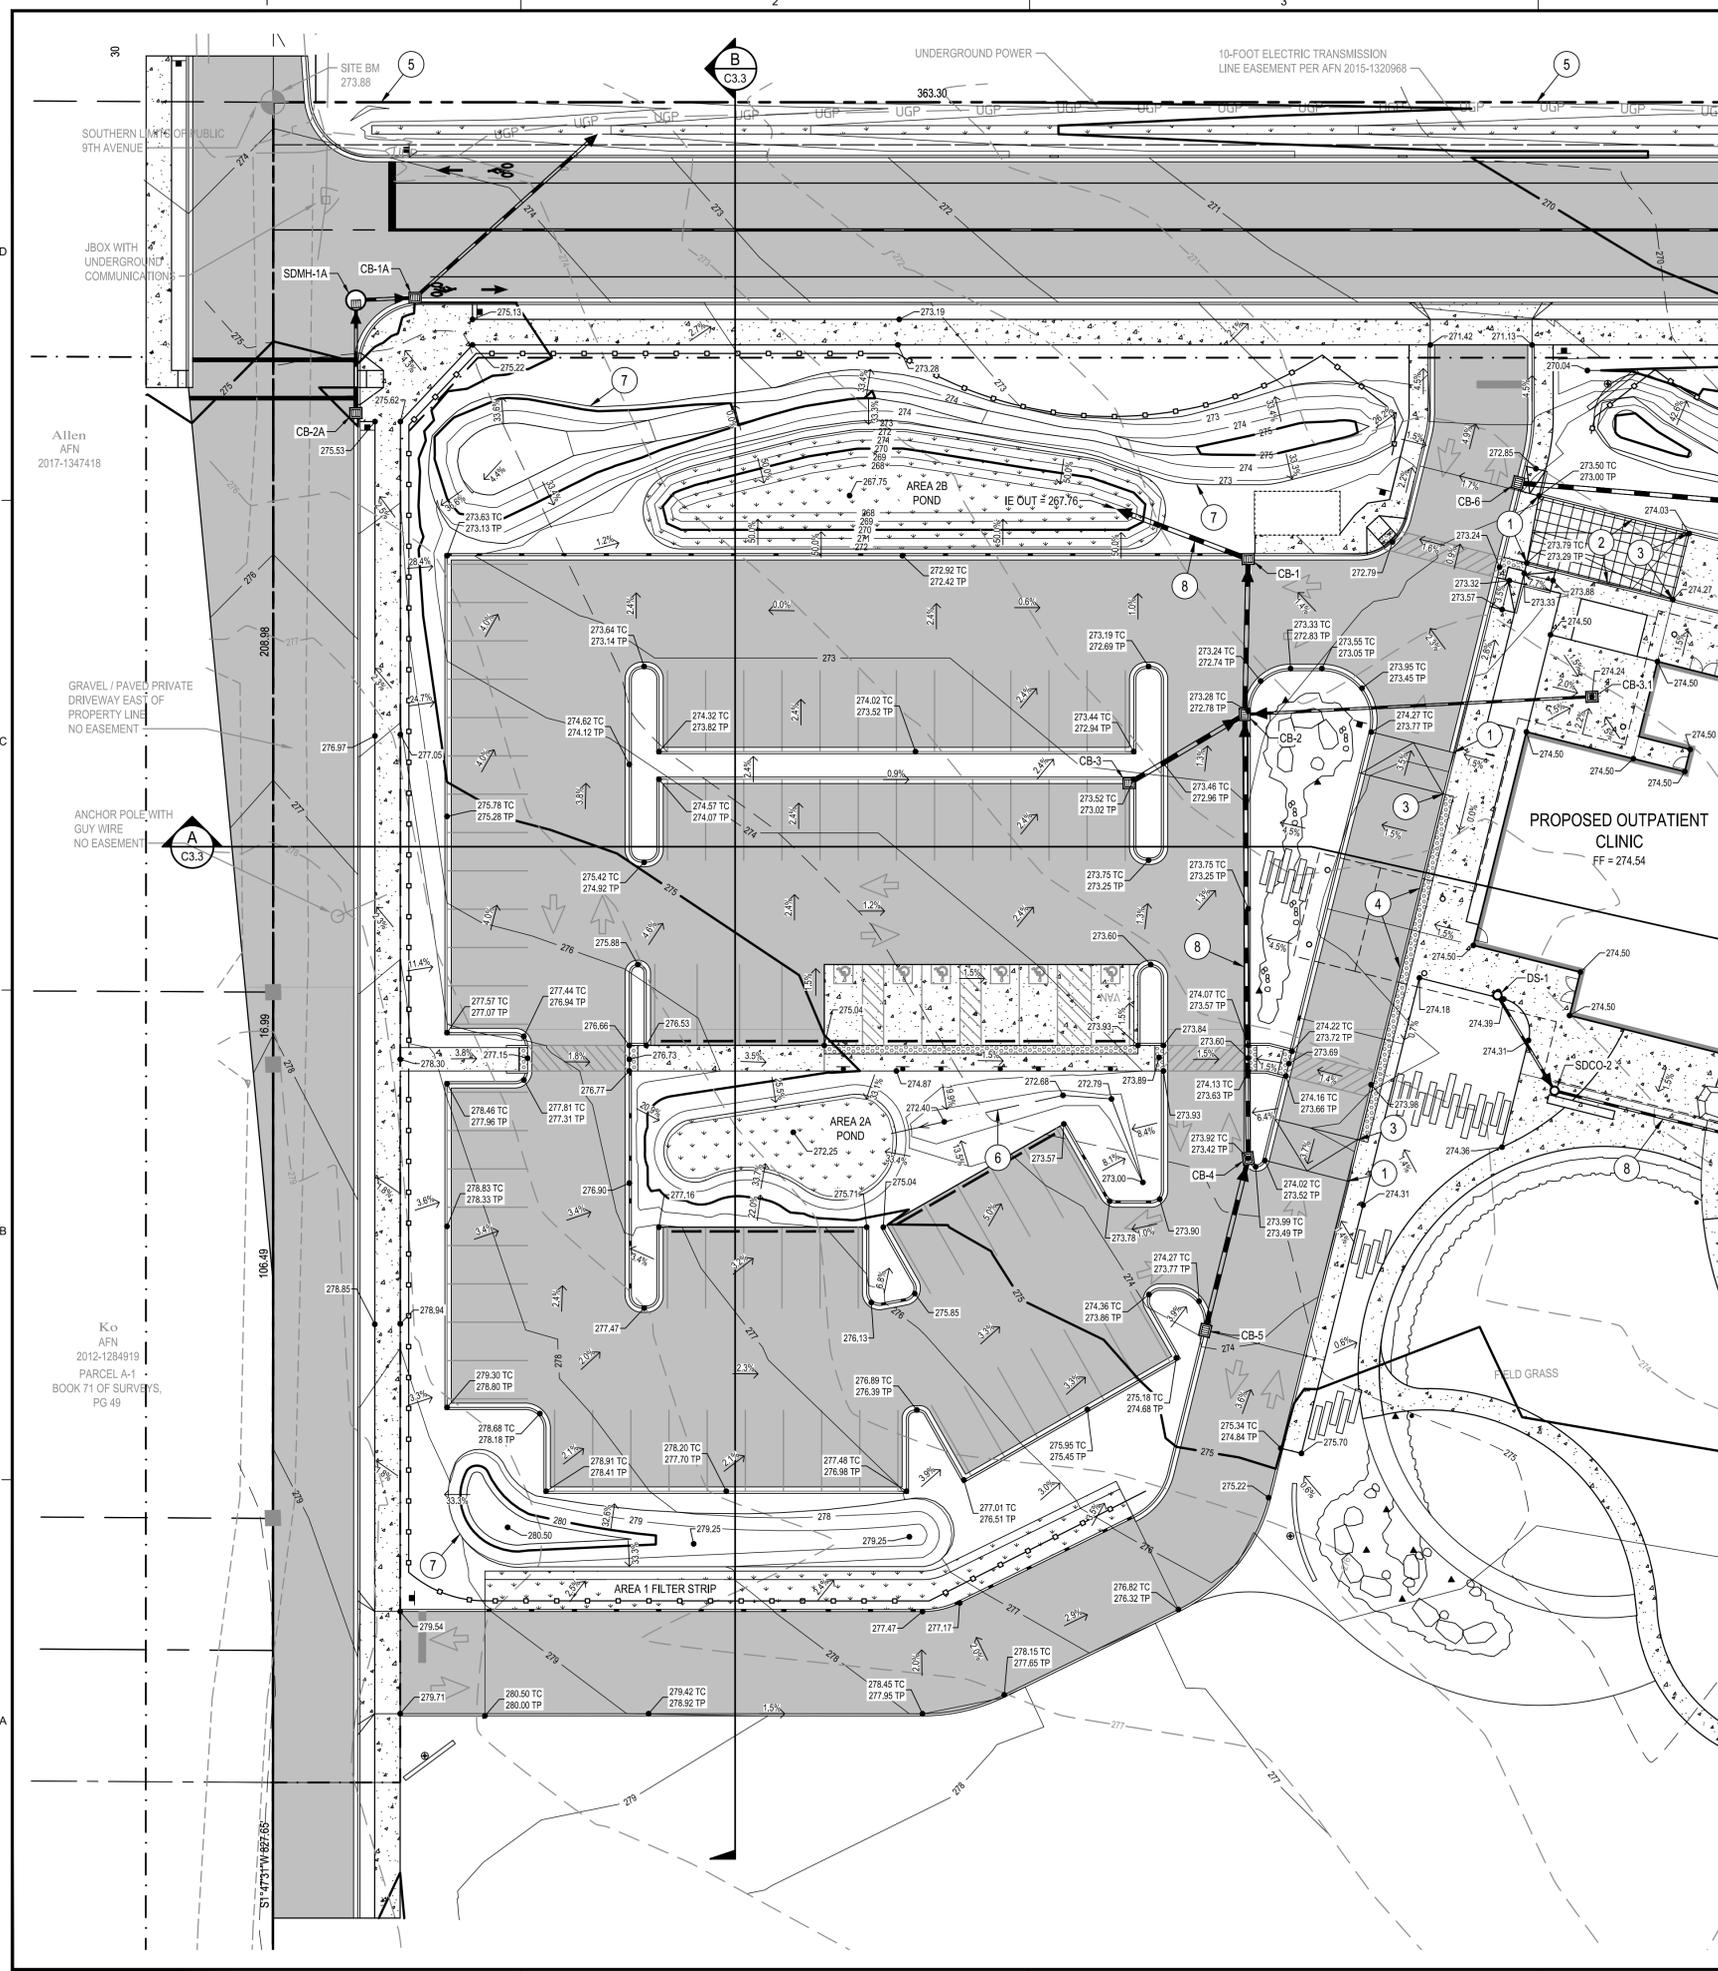

MATCH LINE - SEE SHEET C3.2

JAMESTOWN S'KLALLAM TRIBE
OUTPATIENT CLINIC
SEQUIM, WASHINGTON

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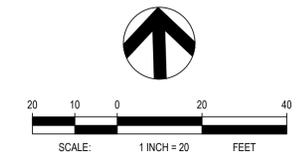
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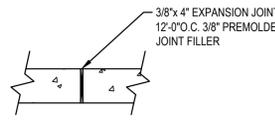
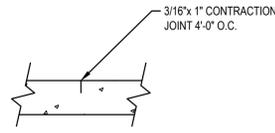
ENLARGED
GRADING
AND
STORMWATER
DRAINAGE
PLAN - WEST

SHEET NO:


C3.1

SHEET OF







1 TYPICAL SIDEWALK JOINT TYPES
C4.3 NTS

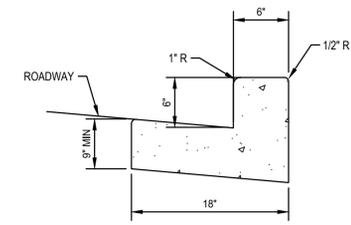


2 CONCRETE TRAFFIC CURB AND GUTTER
C4.3 NTS

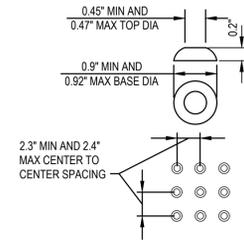

3 DETECTABLE WARNING SURFACE
RAISED TRUNCATED DOMES (IN-LINE)
C4.3 NTS

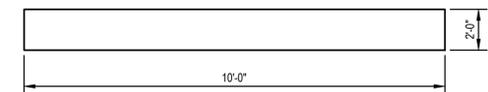


STOP BAR

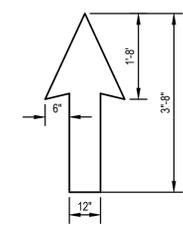


DIRECTIONAL ARROW

NOTE
PROVIDE MARKINGS AS SHOWN
ON PLAN. PAINT WITH TWO COATS
OF WHITE TRAFFIC PAINT

4 PAVEMENT MARKINGS
C4.3 NTS

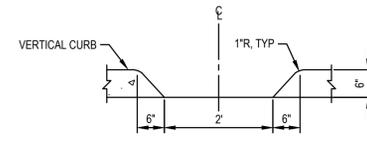


5 NOSE-DOWN CURB DETAIL
C4.3 NTS

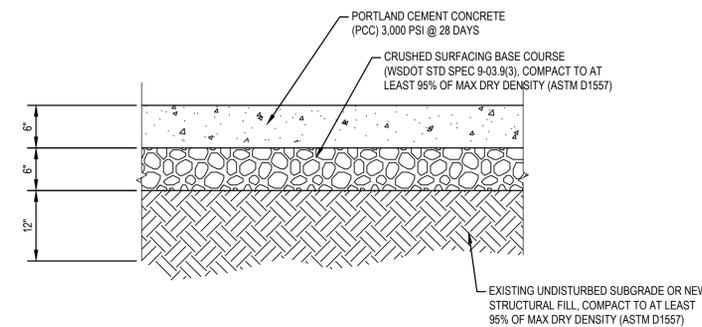


NOTE
1. CONTRACTOR TO FOLLOW THE LATEST EDITION OF
WSDOT SPECIFICATIONS FOR PCC INSTALLATION AND
COMPACTION OF MATERIALS.


6 CONCRETE PAVING
C4.3 NTS

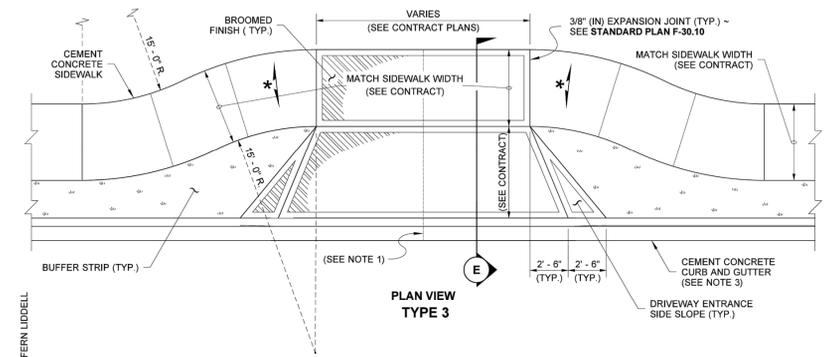

PLAN VIEW
TYPE 3

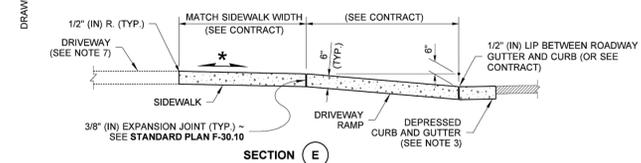

SECTION E

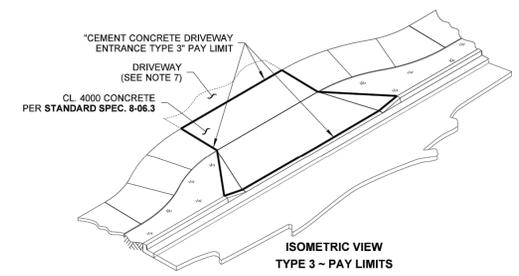

ISOMETRIC VIEW
TYPE 3 - PAY LIMITS

7 CONCRETE DRIVEWAY
C4.3 NTS

JAMESTOWN S'KLALLAM
TRIBE
OUTPATIENT CLINIC
SEQUIM, WASHINGTON

FOR PLAN CHECK
REVIEW

REV	DATE	DESCRIPTION

PROJ. NO.	191652
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CHECKED	ALH
DATE	JAN 10, 2020

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SHEET TITLE:

SITE DETAILS



SHEET NO:

C4.3

SHEET OF



Know what's below.
Call before you dig.

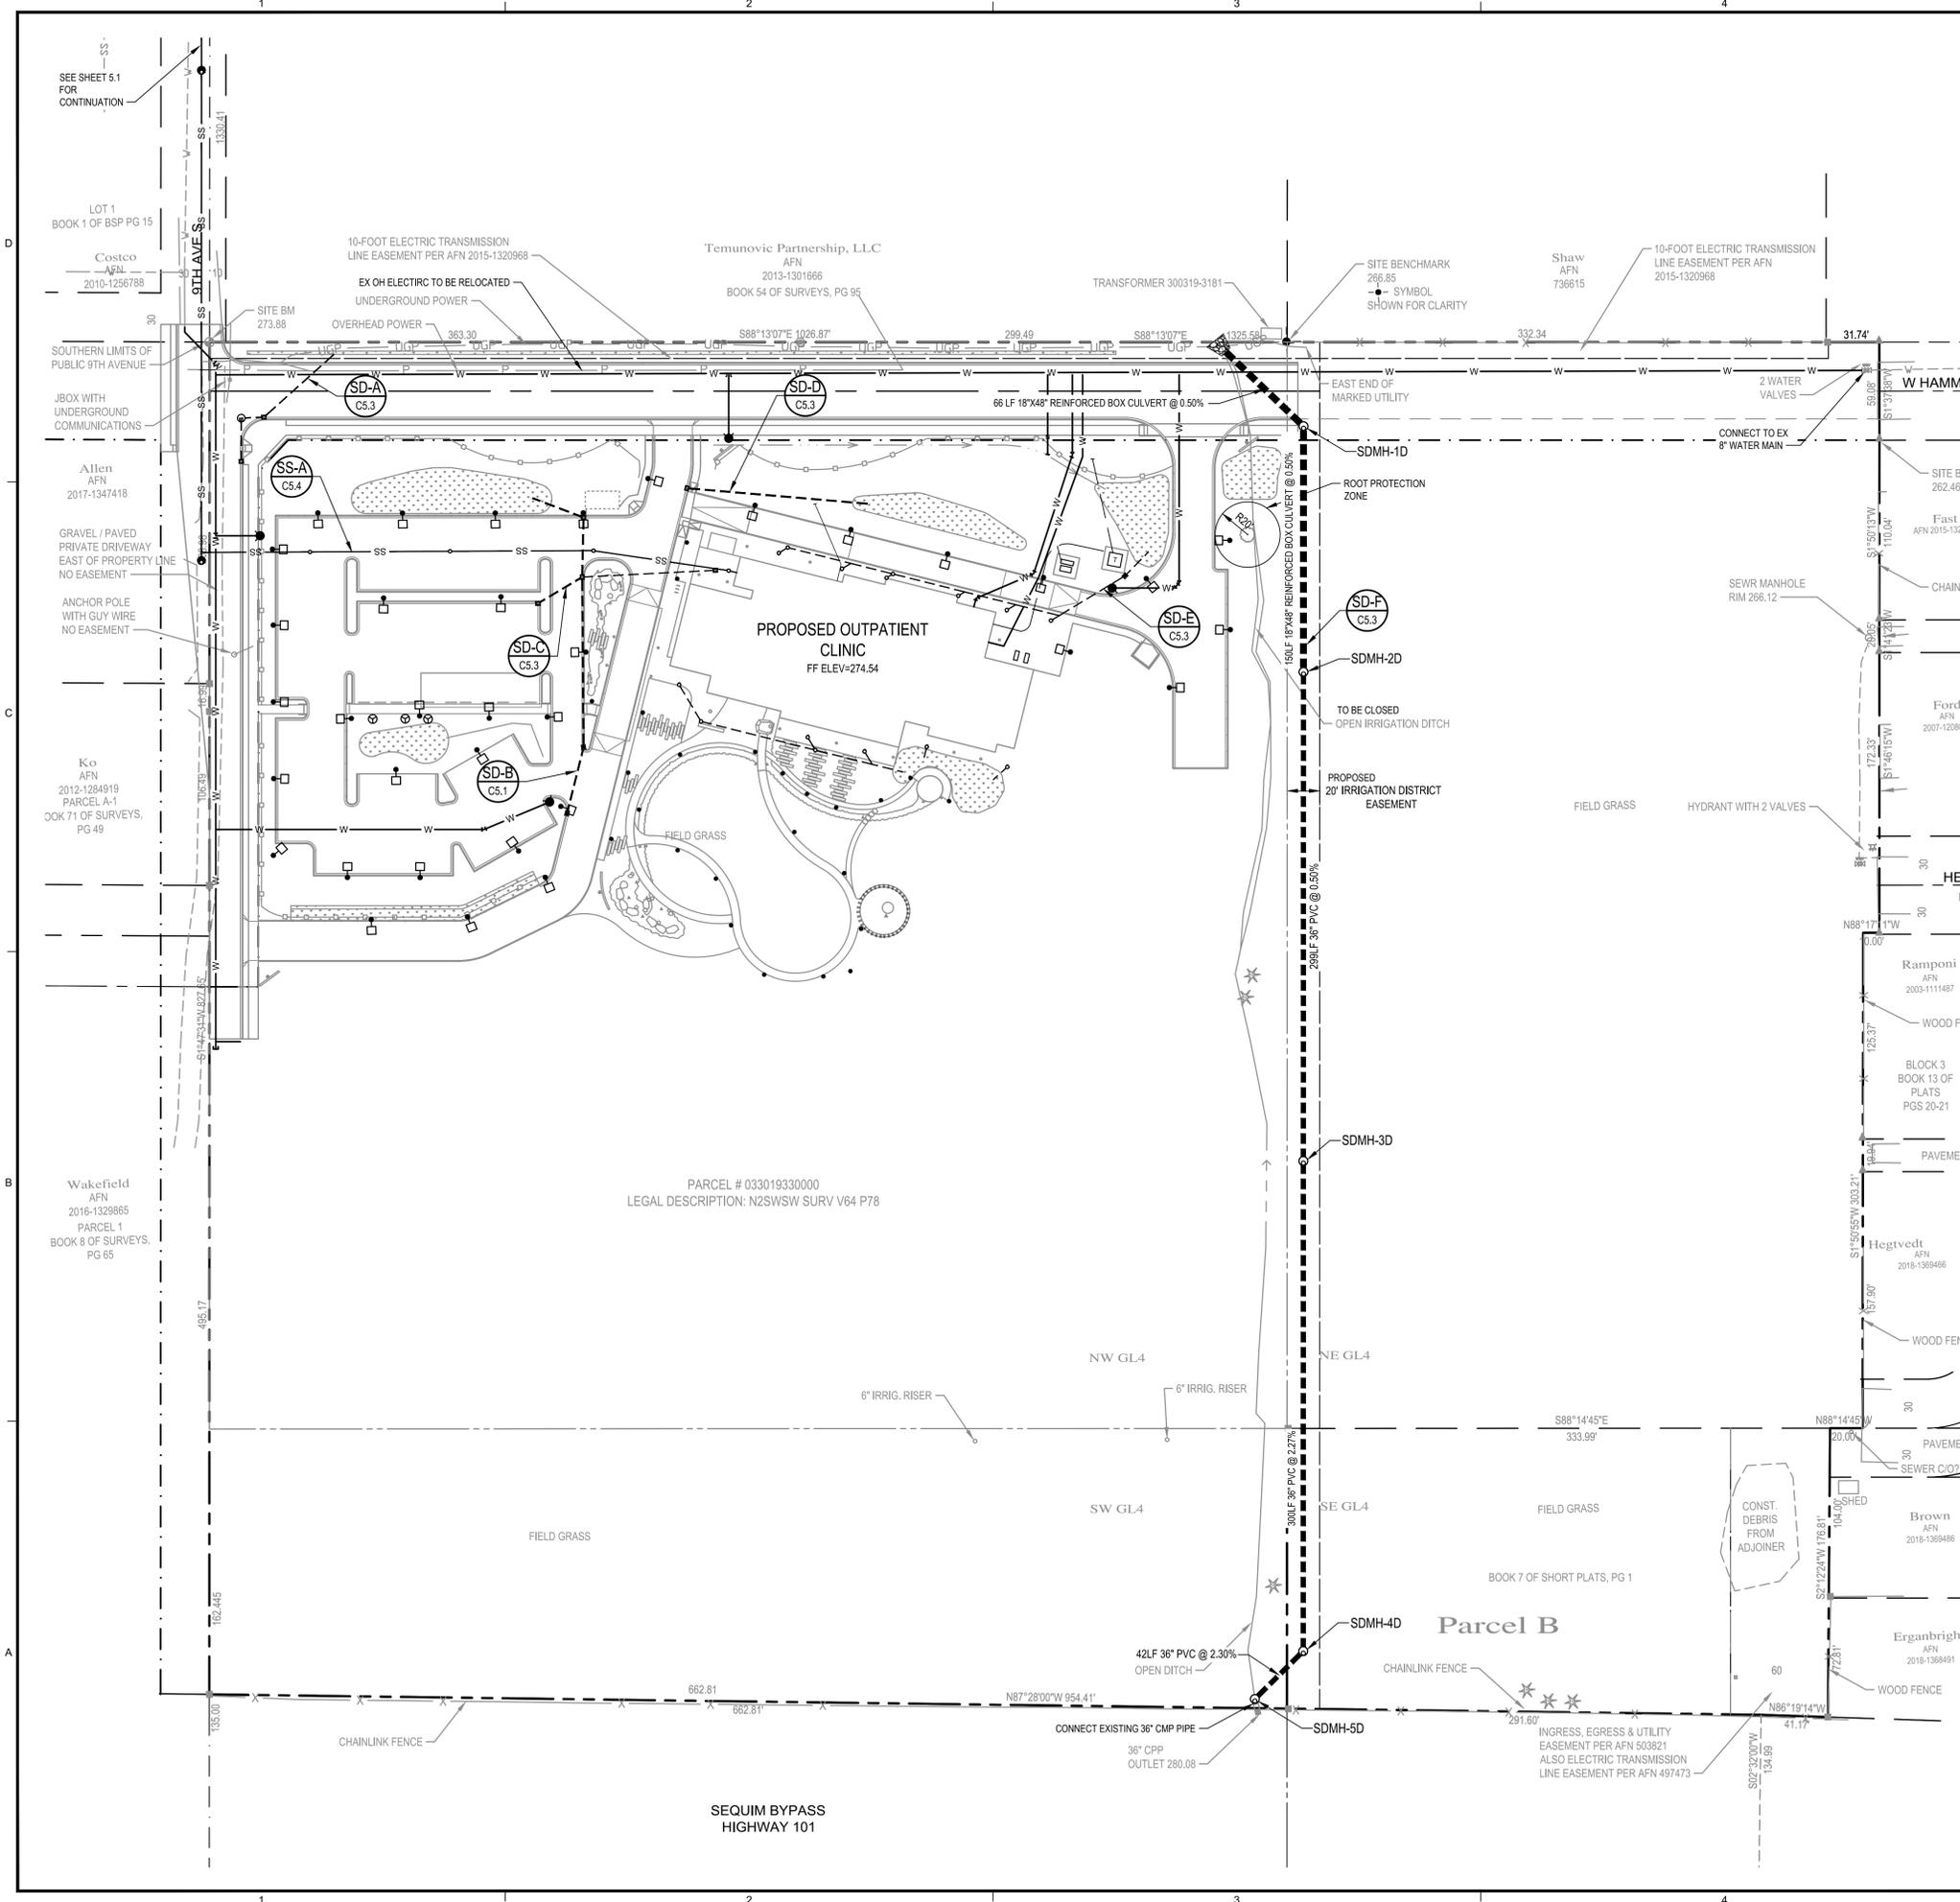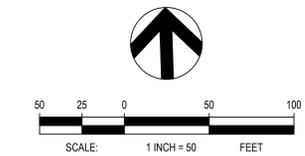

UTILITY LEGEND

- S D M H --- STORM DRAIN LINE
- ▣ CATCH BASIN, TYPE 1
- ▣ CATCH BASIN, TYPE 1 WITH SOLID LID
- ⊙ CATCH BASIN, TYPE 2
- STORM DRAIN/SANITARY SEWER CLEANOUT
- ▣ AREA DRAIN
- ⌋ RAIN GARDEN CULVERT
- EMERGENCY OVERFLOW
- S S --- SANITARY SEWER LINE
- W --- WATER LINE
- SANITARY SEWER MAINTENANCE HOLE
- SANITARY SEWER CLEANOUT
- FIRE HYDRANT
- ⊞ WATER METER
- ⊞ IRRIGATION METER
- ⊞ GATE VALVE
- ⊞ FIRE DEPARTMENT CONNECTION
- ⊞ POST INDICATOR VALVE
- ▲ CONCRETE THRUST BLOCK
- +□ LIGHT POLE
- ▣ OUTFALL PROTECTION

GENERAL NOTES

1. SEE SHEETS C5.1 AND C5.2 FOR ENLARGED UTILITY PLANS.
2. SEE SHEET C5.2 FOR STRUCTURE LOCATION TABLES

GENERAL NOTES (CITY OF SEQUIM)

1. LOCATIONS SHOWN OF EXISTING UTILITIES AND IMPROVEMENTS ARE APPROXIMATE ONLY, AND IT SHALL BE THE RESPONSIBILITY OF THE CONTRACTOR TO VERIFY THE EXACT LOCATIONS OF ALL UTILITIES AND IMPROVEMENTS TO AVOID DAMAGE OR DISTURBANCE.
2. ALL WORK AND MATERIALS MUST BE IN ACCORDANCE WITH THE LATEST REVISION, INCLUDING ADDENDA AND UPDATES, OF THE CITY OF SEQUIM DEVELOPER STANDARDS. CONTRACTOR TO THE CITY OF SEQUIM STANDARDS ON JOB SITE.
3. ROAD RESTORATION SHALL BE PER APPLICABLE CITY OF SEQUIM/CLALLAM COUNTY/WSDOT STANDARDS.
4. CONTRACTOR SHALL "DIAL DIG" (1-800-424-5555) 2 FULL WORKING DAYS PRIOR TO CONSTRUCTION, FOR AID IN LOCATING ANY EXISTING UNDERGROUND UTILITIES.
5. THE CONTRACTOR SHALL KEEP TWO SETS OF PLANS ONSITE AT ALL TIMES FOR RECORDING "AS BUILTS" INFORMATION. ONE SET SHALL BE SUBMITTED TO CITY OF SEQUIM AT COMPLETION OF CONSTRUCTION.
6. PRIOR TO CONSTRUCTION, THE CONTRACTOR SHALL CONTACT THE CITY OF SEQUIM FOR A PRECONSTRUCTION MEETING.
7. EACH WATER AND SEWER CONSTRUCTION DRAWING SHEET SHALL HAVE THE FOLLOWING CITY SIGNATURE BLOCK.

CITY OF SEQUIM
APPROVED FOR CONSTRUCTION

BY: _____ DATE: _____
PUBLIC WORKS DIRECTOR

"THESE PLANS ARE APPROVED FOR CONSTRUCTION FOR A PERIOD OF 12 MONTHS FROM THE DATE SHOWN ABOVE. THE CITY RESERVES THE RIGHT TO MAKE REVISIONS, MODIFICATIONS, AND CHANGES SHOULD CONSTRUCTION BE DELAYED BEYOND THIS TIME LIMIT."

**JAMESTOWN S'KLALLAM TRIBE
OUTPATIENT CLINIC
SEQUIM, WASHINGTON**

**FOR PLAN CHECK
REVIEW**

REV	DATE	DESCRIPTION

PROJ. NO. 191652
DRAWN MG
CHECKED ALH
DATE JAN 10, 2020
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**SHEET TITLE:
OVERALL
UTILITY
PLAN**


SHEET NO:

C5.0

SHEET OF




01/10/2020

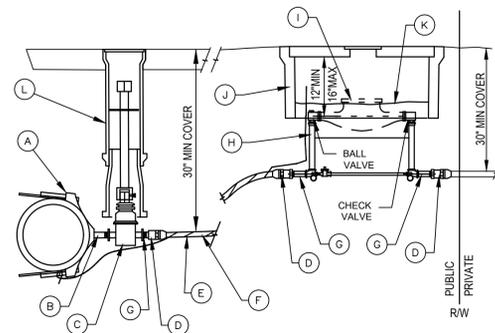


○ PARTS:

- A. ROMAC, FORD OR MUELLER DOUBLE STRAP SERVICE SADDLE WITH I.P. THREAD TO BE USED ON ALL MAINS 4" DIA AND LARGER. ALL NEW TAPS ON EXISTING WATER MAINS SHALL BE DONE BY THE CITY OF EVERETT UTILITIES DEPARTMENT AT THE DEVELOPERS OR CONTRACTORS EXPENSE.
- B. 2" BRASS NIPPLE.
- C. HEAVY DUTY 2" GATE VALVE WITH RESILIENT SEAT AND 2" OPERATING NUT. GATE VALVES SHALL BE "WATEROUS" SERIES 2500 OR CITY APPROVED EQUAL.
- D. MUELLER H-15451 OR H-15428 OR APPROVED EQUAL. USE APPROPRIATE STAINLESS STEEL INSERT STIFFENER WITH POLYETHYLENE TUBING. PHYSICAL BENDS IN POLY PIPE ARE NOT ALLOWED. USE BRASS ELBOWS.
- E. RESIDENTIAL SERVICE
 - 1. PROVIDE 2" POLYETHYLENE TUBING MEETING THE FOLLOWING REQUIREMENTS:
 - a. AWWA C901.
 - b. ASTM D2737, SDR 9 (pe3608/4710).
 - c. ASTM 3350 - PE3608 OR PE4710.
 - 2. PROVIDE A #10 AWG, SINGLE STRAND COPPER WIRE WITH BLUE TYPE UF OR USE COATING SUITABLE FOR DIRECT BURY:
 - a. WRAP WIRE AROUND TUBING, ONE WRAP PER FT. ITS ENTIRE LENGTH.
 - b. SECURE ONE END AROUND THE SADDLE BOLT BETWEEN TWO NUTS AND EXPOSE A MINIMUM OF 18" OF THE OTHER END IN THE METER BOX.
- F. NON-RESIDENTIAL SERVICE
 - 1. PROVIDE 2" TYPE K COPPER TUBING MEETING ASTM B88, ANS/ANSI 61 & APPLICABLE IAPMO STANDARDS.
- G. BRASS ELBOWS & NIPPLES AS NEEDED.
- H. METER SETTERS SHALL BE "FORD" 70 SERIES COPPER SETTER VBH77-12B-11-77 WITH HORIZONTAL INLET AND OUTLET OR APPROVED EQUAL.
- I. METER SHALL BE SUPPLIED AND INSTALLED BY CITY UTILITIES DEPARTMENT AT THE DEVELOPERS OR CONTRACTORS EXPENSE.
- J. PROVIDE METER BOX BODY MANUFACTURED BY "RAVEN PRODUCTS, MODEL RMB-17-30-12", MOUSEHOLES CUT, WITH AASTHO H-20 RATED DI FLUSH SOLID COVER LID OR EQUAL.
- K. PLACE SAWDUST IN METER BOX AROUND PIPE TO TOP OF METER TO PREVENT FREEZING.
- L. ADJUSTABLE VALVE BOX AND EXTENSION SEE STD 504.

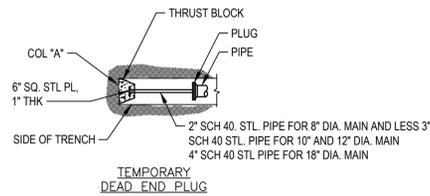


SIZE	TEST PRESSURE (PSI)	THRUST AT FITTINGS IN POUNDS					
		A	B	C	D	E	F
3"	225	2768	3914	2118	1433	1080	543
4"	225	4073	5759	3117	2108	1589	798
6"	225	8393	11869	6423	4344	3275	1645
8"	225	14468	20460	11073	7489	5645	2836
10"	225	21758	30770	16652	11263	8489	4265
12"	225	30780	43529	23558	15933	12010	6034
14"	225	41355	58485	31652	21407	16136	8107
16"	225	53483	75636	40934	27685	20868	10484
24"	225	117608	166322	90013	60878	45888	23055

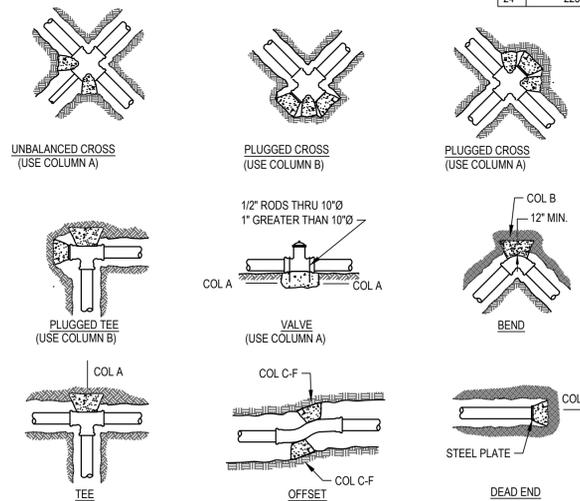


- NOTES:
- CONTRACTOR TO PROVIDE BLOCKING ADEQUATE TO WITHSTAND FULL TEST PRESSURE.
 - DIVIDE THRUST BY SAFE BEARING LOAD TO DETERMINE REQUIRED AREA (IN SQUARE FEET) OF CONCRETE TO DISTRIBUTE LOAD.
 - AREAS TO BE ADJUSTED FOR OTHER PRESSURE CONDITIONS.
 - PROVIDE TWO 1" MINIMUM DIAMETER RODS ON VALVES UP THROUGH 10" DIAMETER. VALVES LARGER THAN 10" REQUIRE SPECIAL TIE ROD DESIGN.
 - USE 3000 PSI CONCRETE FOR THRUST BLOCKING.

1 2" METERED WATER SERVICE
C5.4 NTS

2 TYPICAL THRUST BLOCKING DETAILS
C5.4 NTS

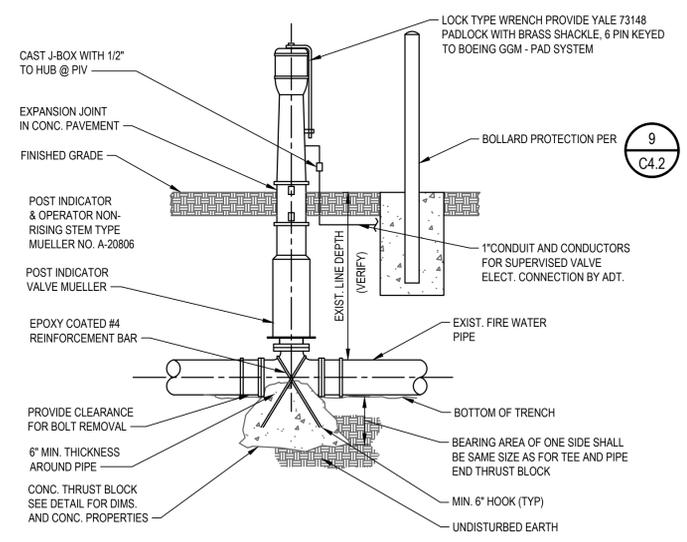

3 POST INDICATOR AND VALVE DETAIL
C5.4 NTS

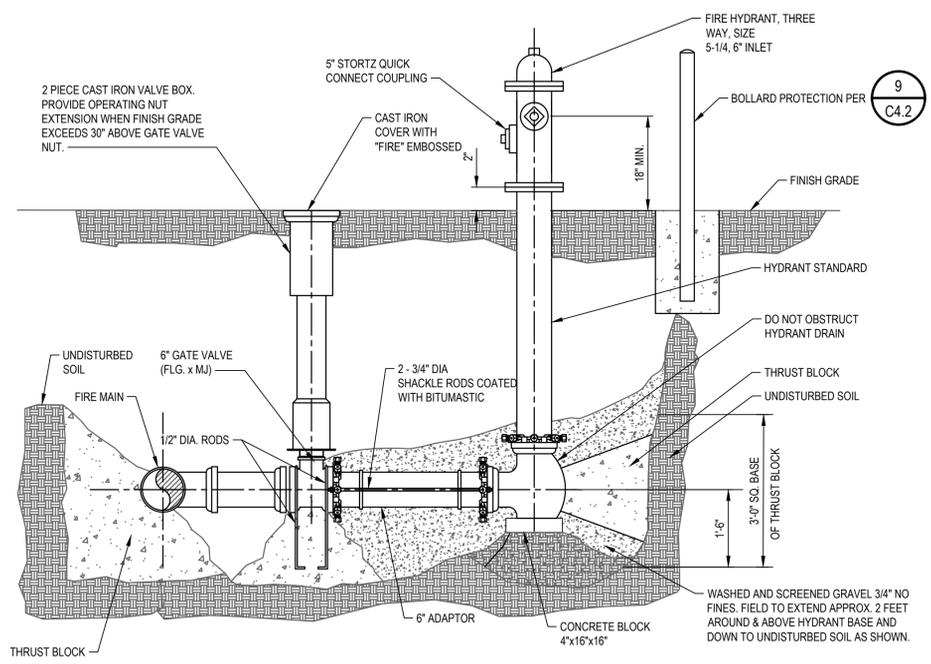

4 TYPICAL FIRE HYDRANT DETAIL
C5.4 NTS

JAMESTOWN S'KLALLAM TRIBE
OUTPATIENT CLINIC
SEQUIM, WASHINGTON

FOR PLAN CHECK REVIEW

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SHEET TITLE:
UTILITY DETAILS


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C5.4


SHEET OF




Know what's below.
Call before you dig.

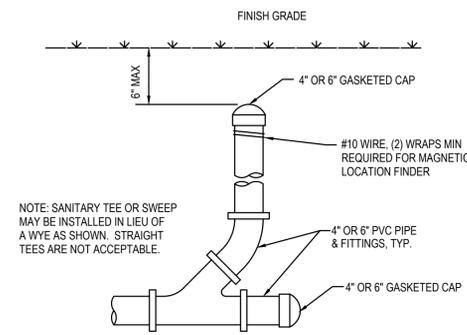

1 CLEANOUT DETAIL - UNPAVED
C5.5 NTS

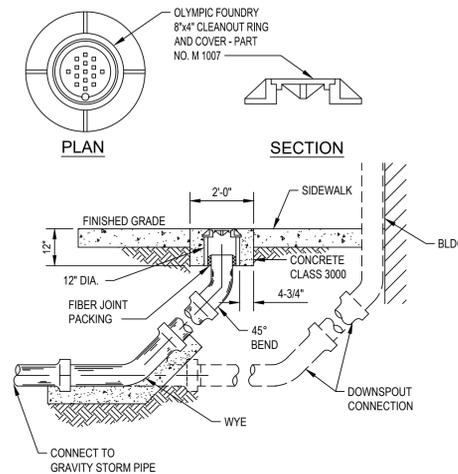


2 DOWNSPOUT CONNECTION DETAIL
C5.5 NTS

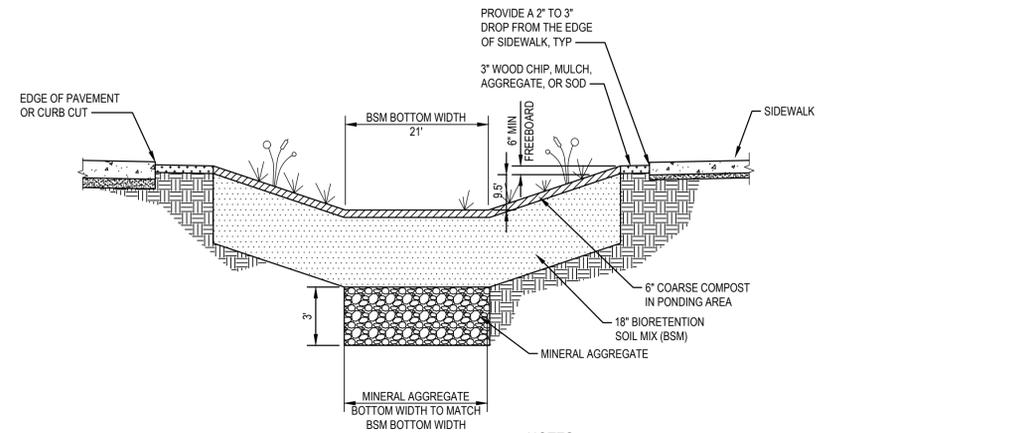

NOTES

1. SCARIFY SUBGRADE 3\"/>

3 BIORETENTION CELL DETAIL
C5.5 NTS

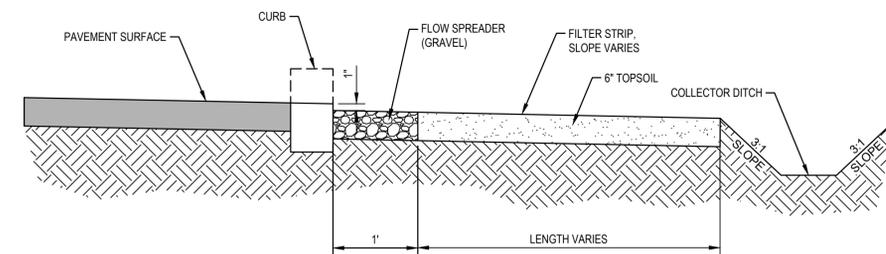

4 FILTER STRIP DETAIL
C5.5 NTS

JAMESTOWN S'KLALLAM TRIBE
OUTPATIENT CLINIC
SEQUIM, WASHINGTON

FOR PLAN CHECK
REVIEW

REV	DATE	DESCRIPTION
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DATE JAN 10, 2020

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SHEET TITLE:

UTILITY DETAILS

SHEET NO:

C5.5

SHEET OF



Know what's below.
Call before you dig.



GENERAL NOTES

- SEE SHEET C6.0 FOR TYPICAL ROADWAY SECTIONS.
- SEE SITE PLANS FOR SITE INFORMATION AND CROSS SECTIONS.
- SEE GRADING PLANS FOR GRADING INFORMATION FOR CURB, RAMPS, WALKWAYS AND DRIVEWAY.
- CURB AND GUTTER STATION/OFFSET CALLOUTS ARE TO FLOW LINE.
- SEE WSDOT STANDARDS SECTION "M" FOR CHANNELIZATION MATERIAL SPECIFICATIONS.

CONSTRUCTION NOTES


- CONSTRUCT CEMENT CONCRETE APPROACH PER WSDOT STD PLAN F-80.10.03, TYPE 3 - MODIFIED, SEE DETAIL 7, SHEET C4.3
- CONSTRUCT NOSE-DOWN CURB PER DETAIL 4, SHEET C4.3
- PLANTER STRIP, SEE TYPICAL ROADWAY SECTIONS, SHEET C6.0
- CONSTRUCT CEMENT CONCRETE CURB AND GUTTER PER DETAIL 2, SHEET C4.3
- CONCRETE SIDEWALK, SEE TYPICAL ROADWAY SECTIONS, SHEET C6.0

CHANNELIZATION NOTES

- INSTALL 12" WIDE THERMOPLASTIC PARALLEL BAR MARKING CROSSWALK MARKINGS PER PLAN
- YELLOW DOUBLE CENTERLINE LINE PER WSDOT STD PLAN M-20.10.02
- INSTALL THERMOPLASTIC BIKE LANE SYMBOL (WITH ARROWS) PER WSDOT STD PLAN M-8.50.02, STATION IS TO FRONT TIP OF ARROW
- INSTALL 4" WHITE SOLID LANE LINE PER WSDOT STD PLAN M-20.10.02
- INSTALL 12" WIDE STOP BAR PER WSDOT STD PLAN M-24.60.04


SIGNAGE NOTES

- "STOP" SIGN
- "25 MPH SPEED LIMIT" SIGN
- "NO TROUGH TRAFFIC" SIGN
- "ROAD NARROWS" SIGN
- "BIKE LANE" SIGN

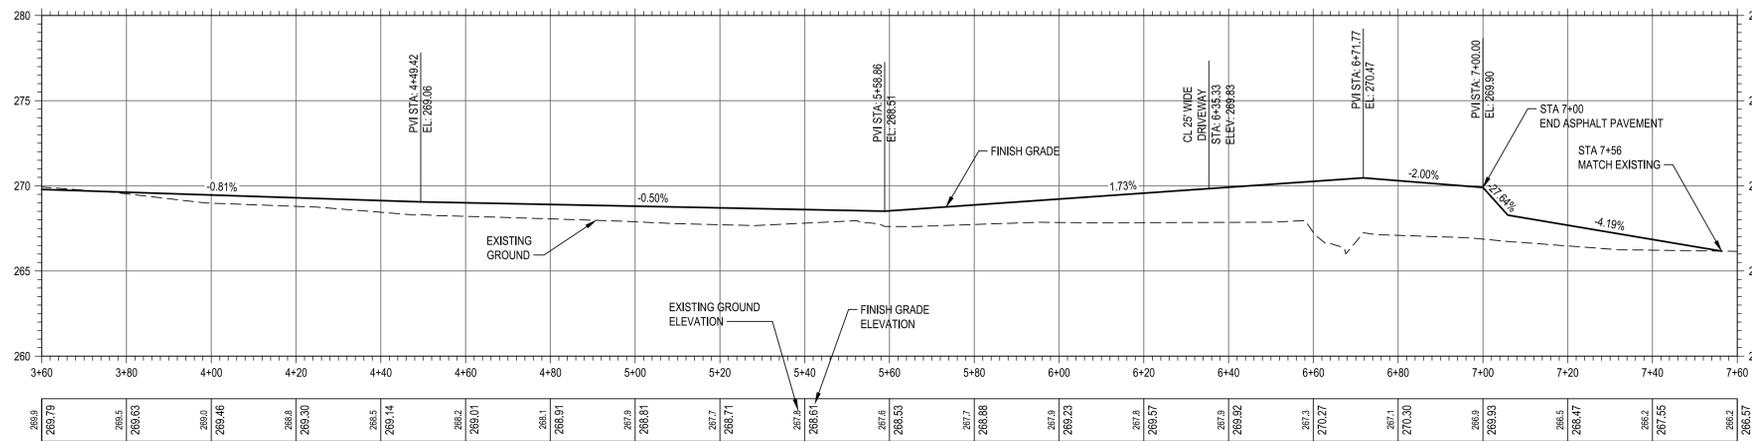


W HAMMOND STREET PROFILE

SCALE: 1" = 20' (HORIZ.) 1" = 5' (VERT.)

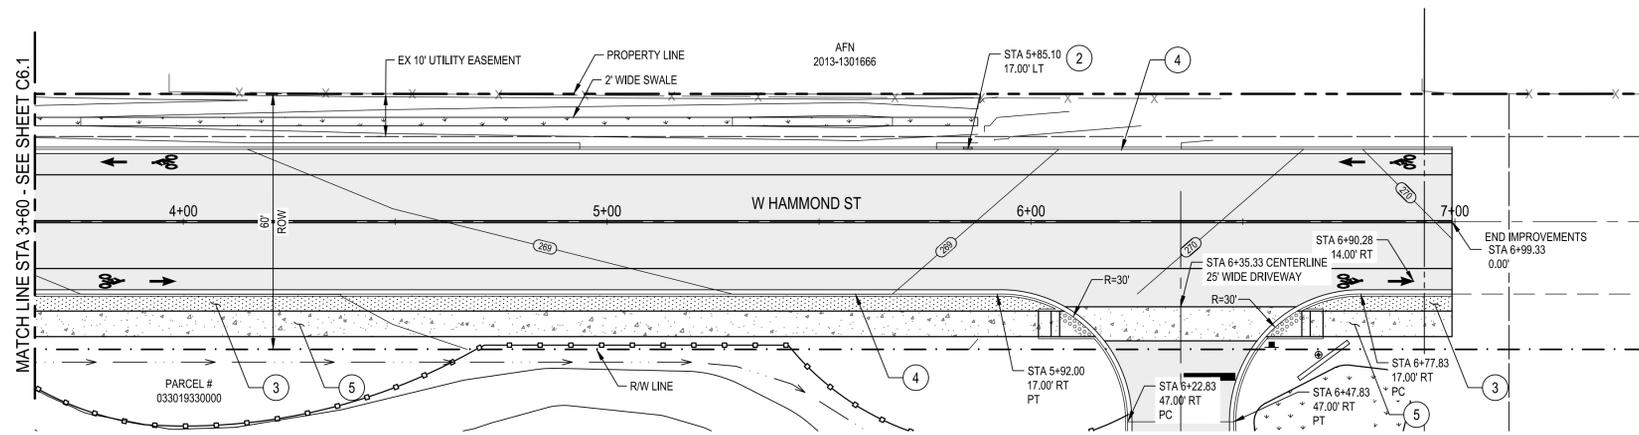


W HAMMOND STREET - ROADWAY CONSTRUCTION PLAN

SCALE: 1" = 20'

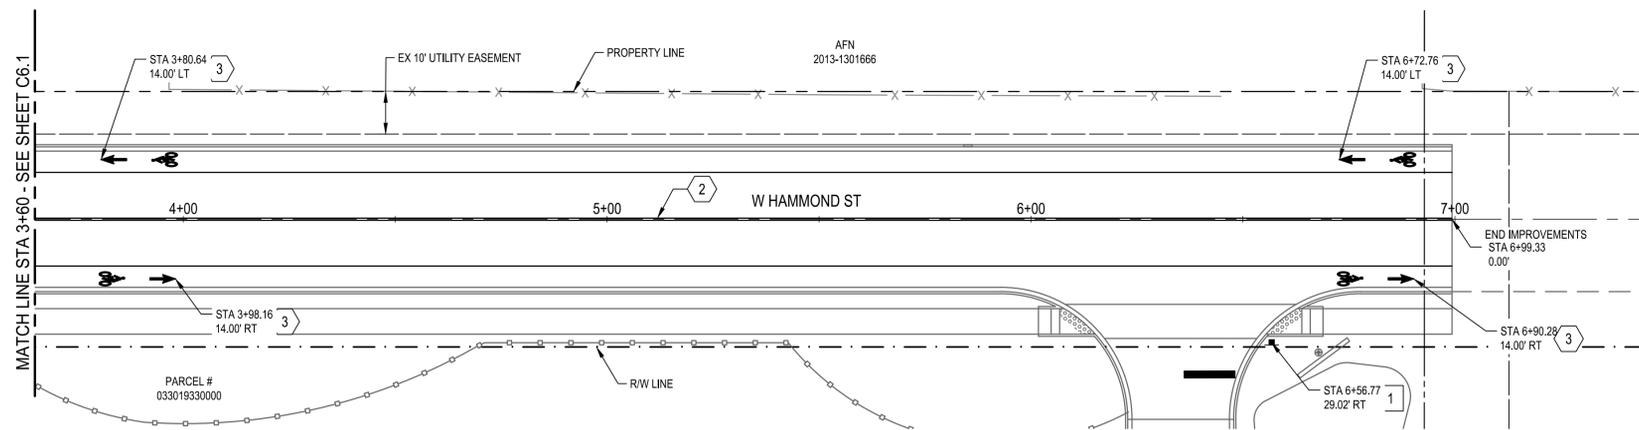

W HAMMOND STREET - CHANNELIZATION PLAN PLAN

SCALE: 1" = 20'

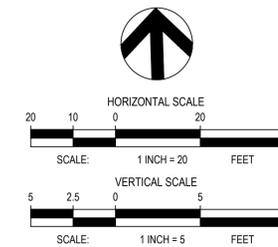

JAMESTOWN S'KLALLAM TRIBE
OUTPATIENT CLINIC
SEQUIM, WASHINGTON

FOR PLAN CHECK
REVIEW

REV	DATE	DESCRIPTION

PROJ. NO.	191652
DRAWN	MPB
CHECKED	ALH
DATE	JAN 10, 2020

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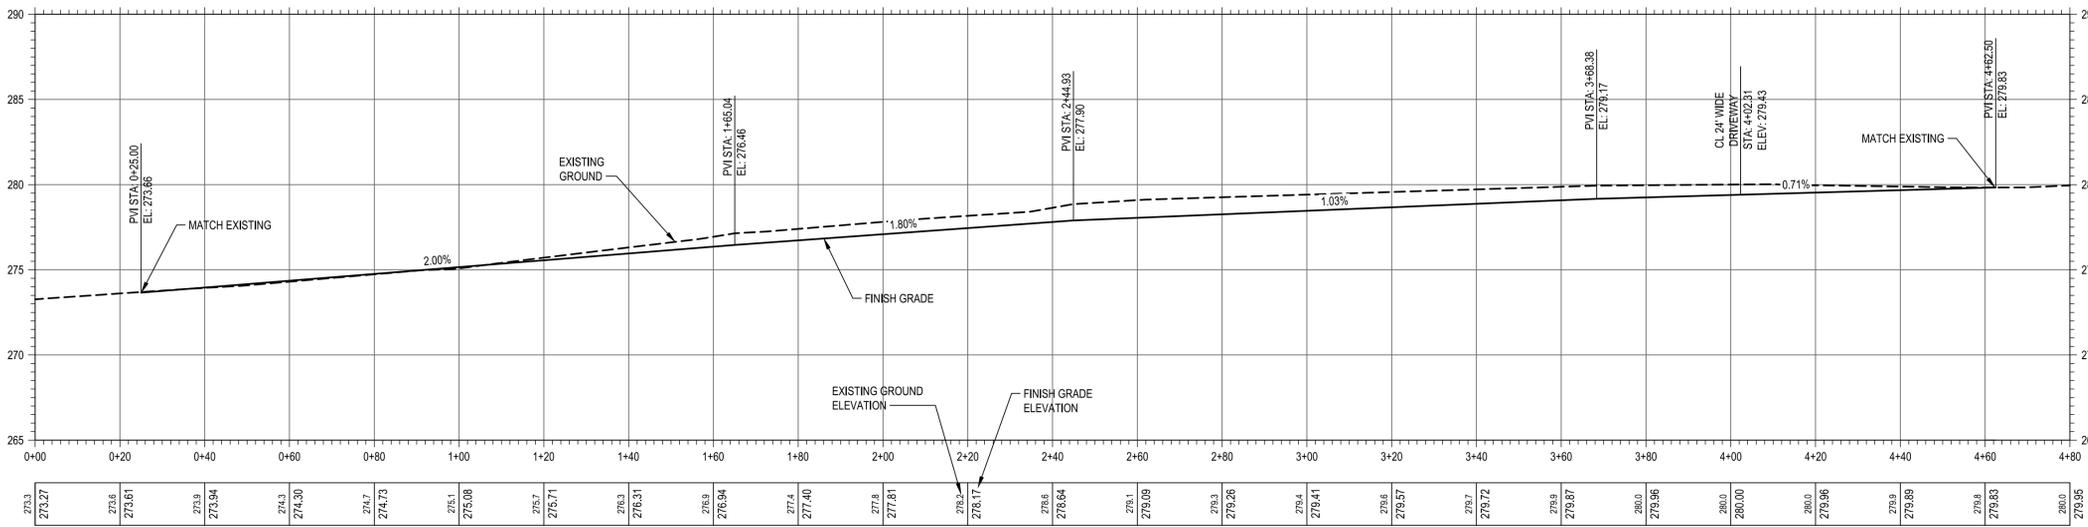
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**HAMMOND STREET
ROADWAY PLANS
AND PROFILE**


SHEET NO:

C6.2


SHEET OF



S 9TH AVE PROFILE
SCALE: 1" = 20' (HORIZ.) 1" = 5' (VERT.)

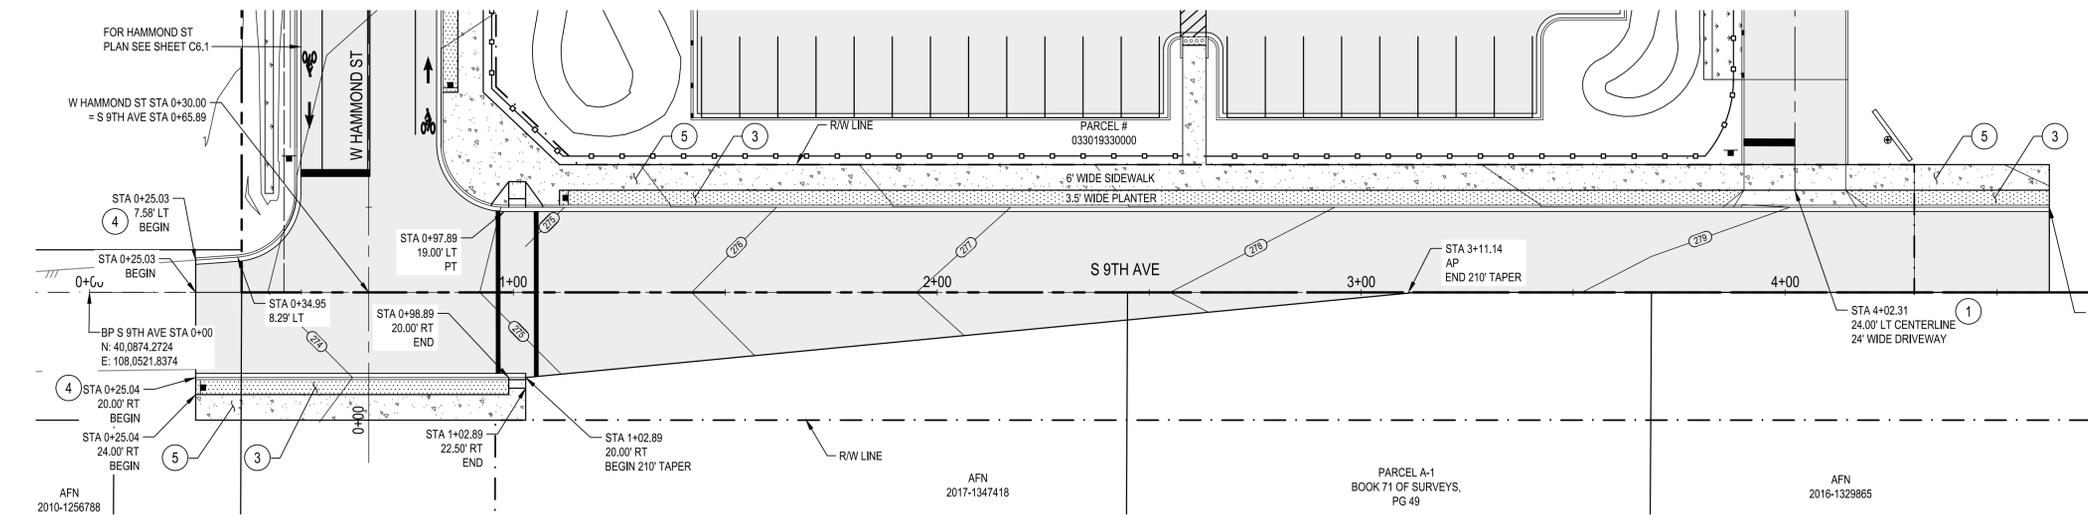

S 9TH AVE - ROADWAY CONSTRUCTION PLAN
SCALE: 1" = 20'

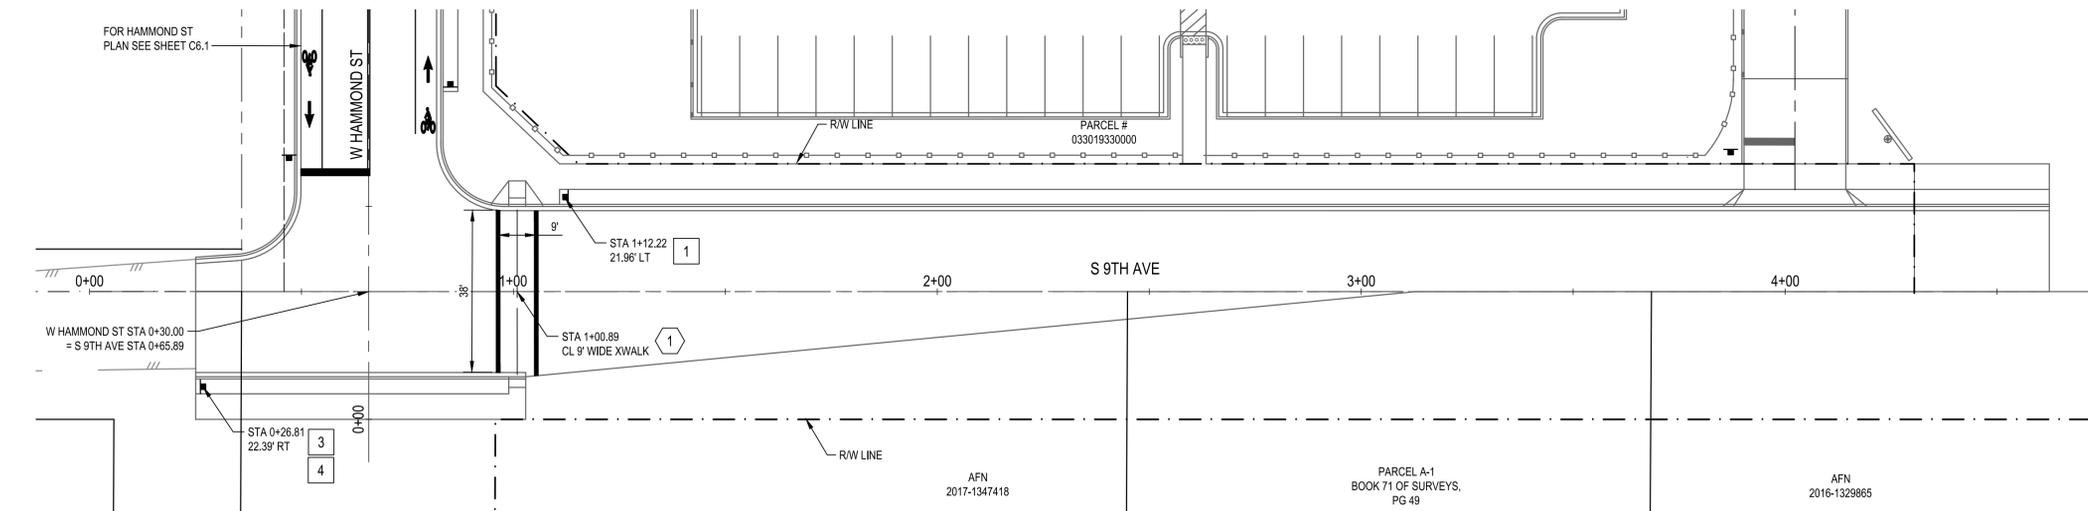

S 9TH AVE - CAHNNELIZATION PLAN PLAN
SCALE: 1" = 20'

GENERAL NOTES

- SEE SHEET C6.0 FOR TYPICAL ROADWAY SECTIONS.
- SEE SITE PLANS FOR SITE INFORMATION AND CROSS SECTIONS.
- SEE GRADING PLANS FOR GRADING INFORMATION FOR CURB, RAMPS, WALKWAYS AND DRIVEWAY.
- CURB AND GUTTER STATION/OFFSET CALLOUTS ARE TO FLOW LINE.
- SEE WSDOT STANDARDS SECTION "M" FOR CHANNELIZATION MATERIAL SPECIFICATIONS.

CONSTRUCTION NOTES

- CONSTRUCT CEMENT CONCRETE APPROACH PER WSDOT STD PLAN F-80.10.03, TYPE 3 - MODIFIED. SEE DETAIL 7, SHEET C4.3
- CONSTRUCT NOSE-DOWN CURB PER DETAIL 4, SHEET C4.3
- PLANTER STRIP. SEE TYPICAL ROADWAY SECTIONS, SHEET C6.0
- CONSTRUCT CEMENT CONCRETE CURB AND GUTTER PER DETAIL 2, SHEET C4.3
- CONCRETE SIDEWALK. SEE TYPICAL ROADWAY SECTIONS, SHEET C6.0

CHANNELIZATION NOTES

- INSTALL 12" WIDE THERMOPLASTIC PARALLEL BAR MARKING CROSSWALK MARKINGS PER PLAN
- YELLOW DOUBLE CENTERLINE LINE PER WSDOT STD PLAN M-20.10.02
- INSTALL THERMOPLASTIC BIKE LANE SYMBOL (WITH ARROWS) PER WSDOT STD PLAN M-9.50.02. STATION IS TO FRONT TIP OF ARROW
- INSTALL 4" WHITE SOLID LANE LINE PER WSDOT STD PLAN M-20.10.02
- INSTALL 12" WIDE STOP BAR PER WSDOT STD PLAN M-24.60.04

SIGNAGE NOTES

- "STOP" SIGN
- "25 MPH SPEED LIMIT" SIGN
- "NO TROUGH TRAFFIC" SIGN
- "ROAD NARROWS" SIGN
- "BIKE LANE" SIGN

JAMESTOWN S'KLALLAM TRIBE
OUTPATIENT CLINIC
SEQUIM, WASHINGTON

FOR PLAN CHECK REVIEW

REV	DATE	DESCRIPTION

PROJ. NO. 191652
DRAWN MPB
CHECKED ALH
DATE JAN 10, 2020

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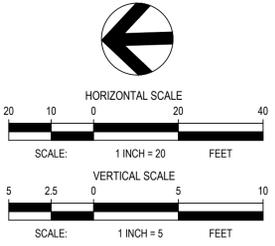
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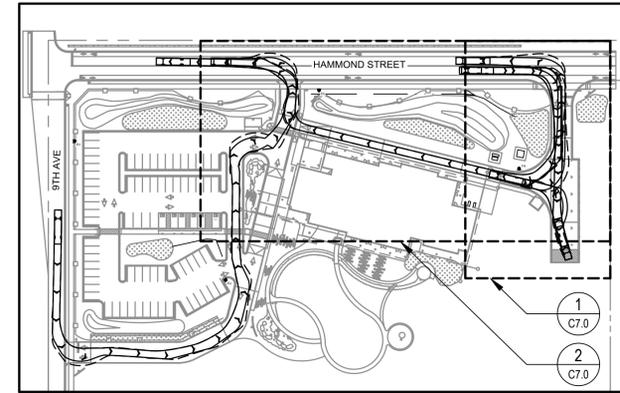
9TH AVE
PLAN AND
PROFILE

SHEET NO:

C6.3

SHEET OF






KEY PLAN


SCALE: 1" = 100'

LEGEND


FH FIRE HYDRANT

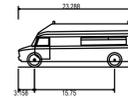


Horton 453 Type I Ford E-Series Ambulance
 Overall Length 23.288ft
 Overall Width 8.021ft
 Overall Body Height 9.000ft
 Min Body Ground Clearance 1.075ft
 Track Width 8.021ft
 Lock-to-lock time 5.00s
 Curb to Curb Turning Radius 27.400ft

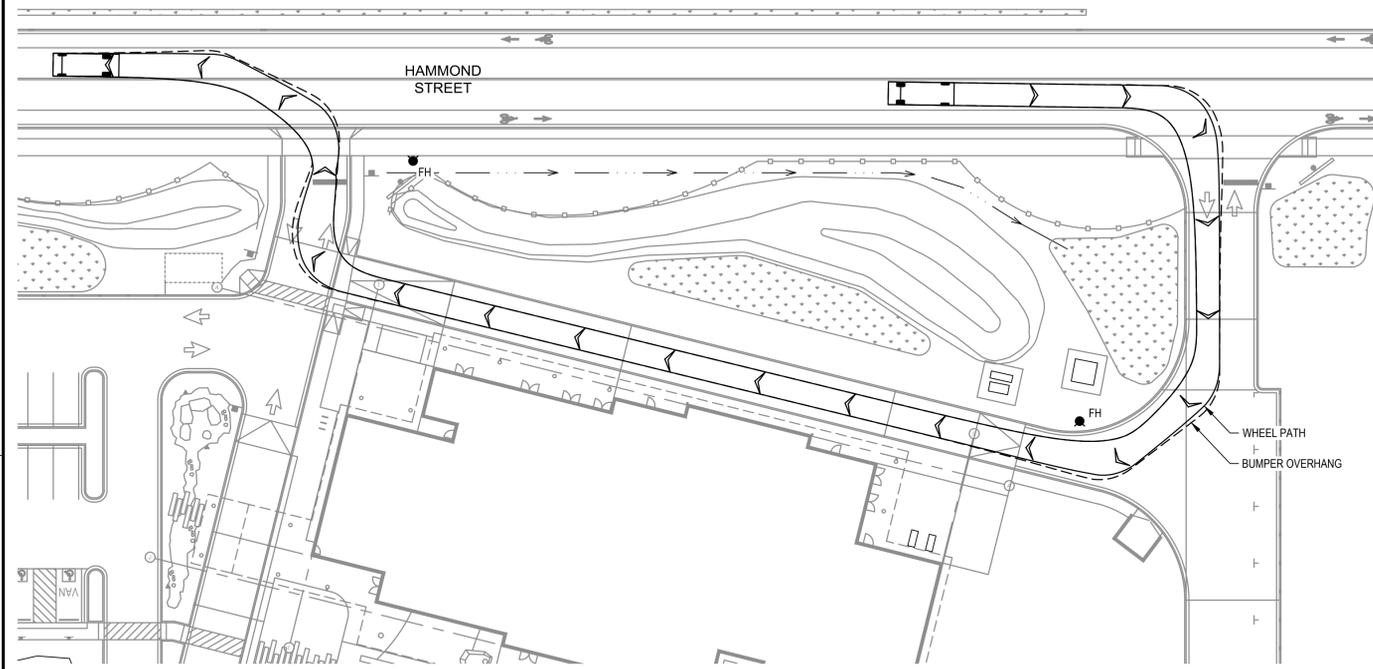



1 AMBULANCE CIRCULATION
SCALE: 1" = 30'

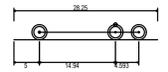

Trash Compactor Truck
 Overall Length 28.250ft
 Overall Width 11.336ft
 Overall Body Height 14.73ft
 Min Body Ground Clearance 1.473ft
 Track Width 8.420ft
 Lock-to-lock time 5.00s
 Max Steering Angle (Virtual) 35.00°

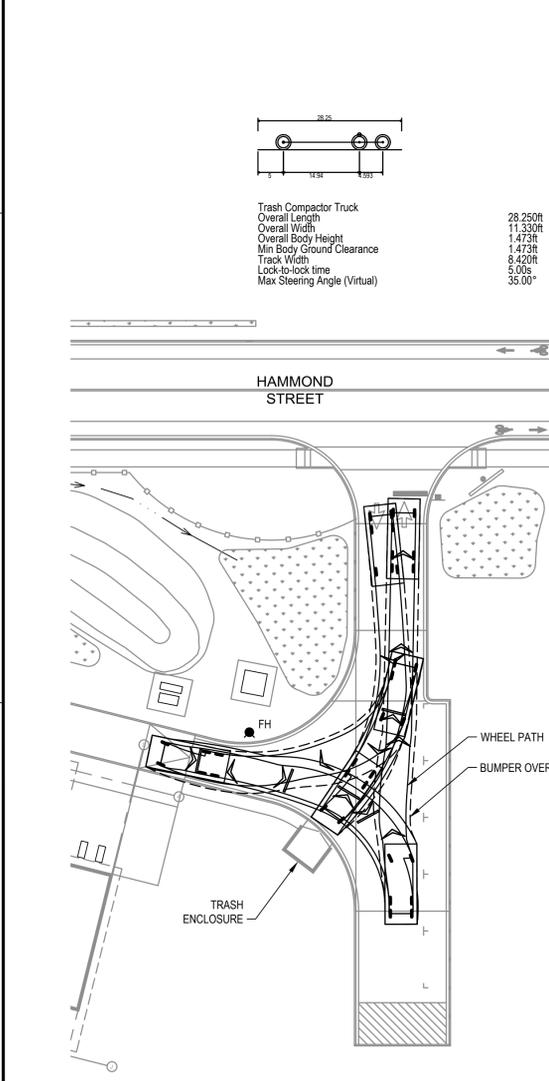

2 REFUSE COLLECTOR TRUCK CIRCULATION
SCALE: 1" = 30'

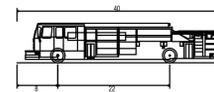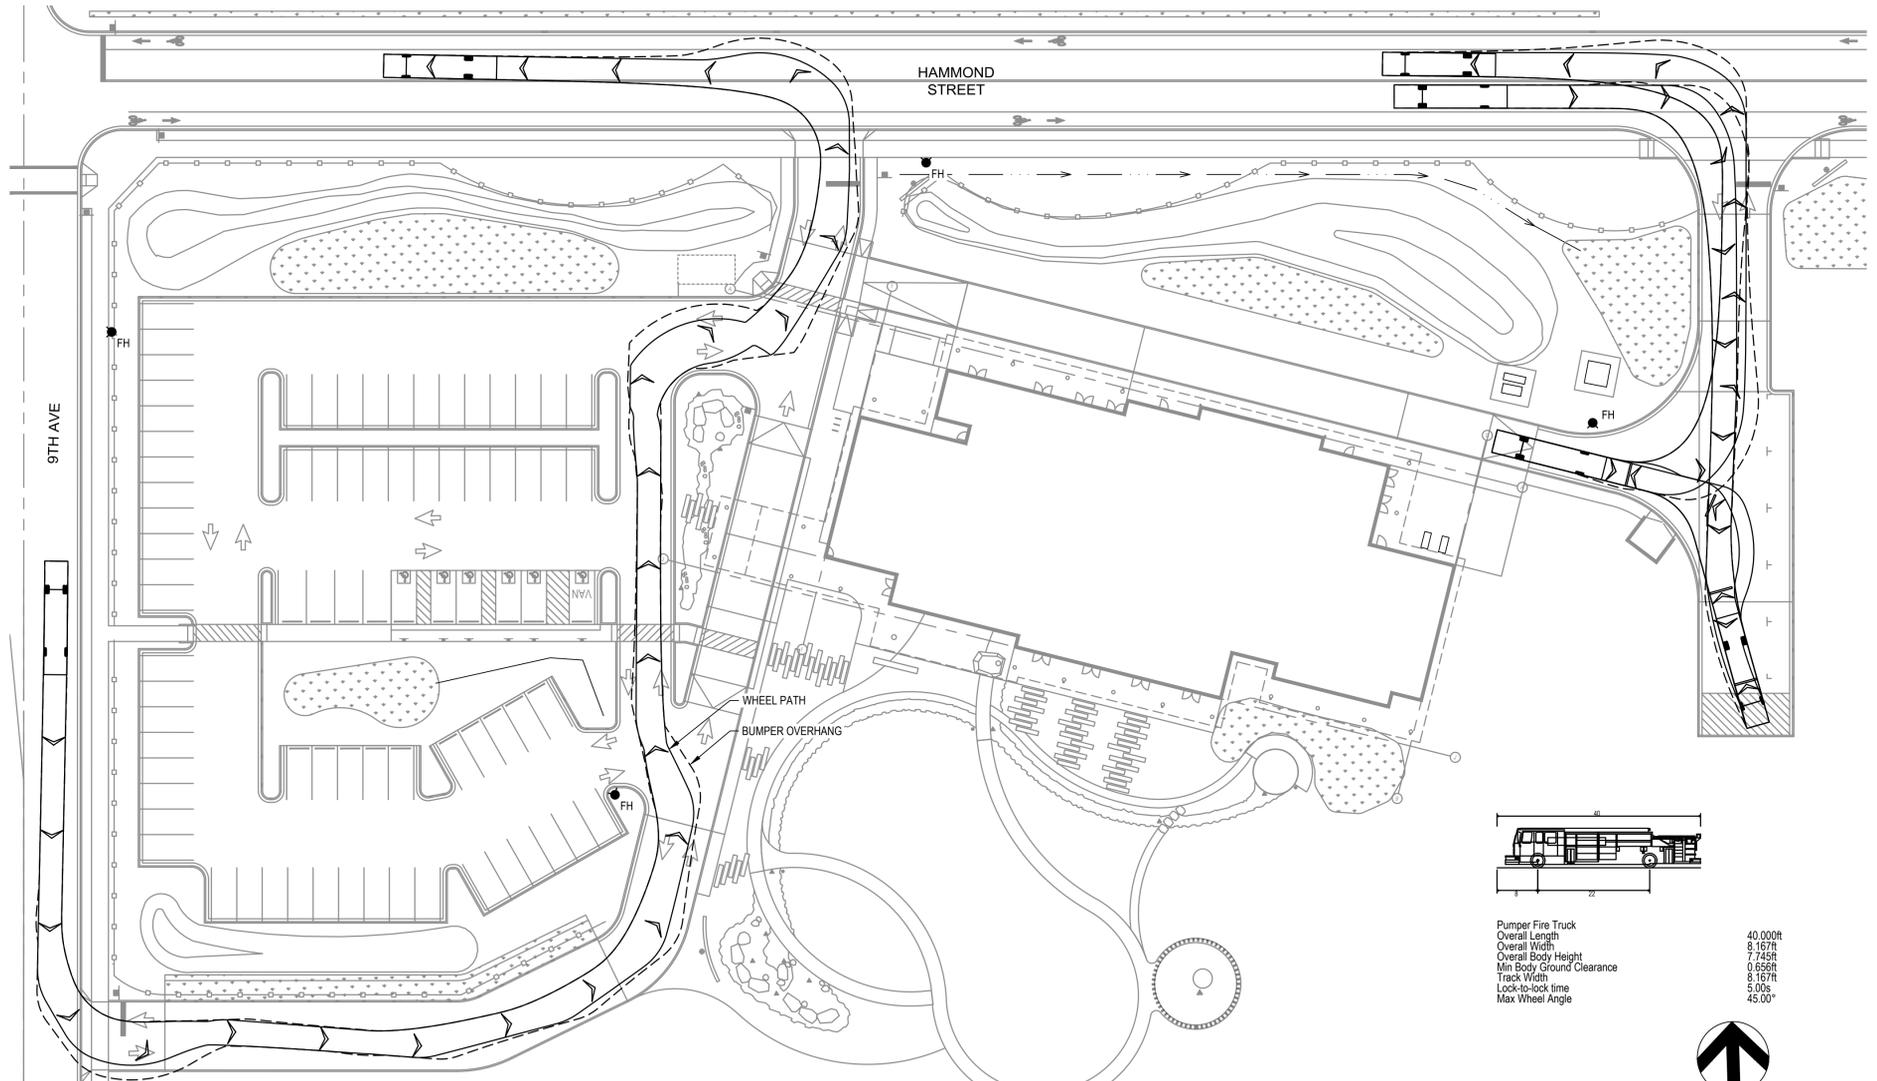

Pumper Fire Truck
 Overall Length 40.000ft
 Overall Width 8.167ft
 Overall Body Height 7.745ft
 Min Body Ground Clearance 0.656ft
 Track Width 8.167ft
 Lock-to-lock time 5.00s
 Max Wheel Angle 45.00°

FIRE TRUCK CIRCULATION

SCALE: 1" = 30'



30 15 0 30 60
SCALE: 1 INCH = 30 FEET

JAMESTOWN S'KLALLAM TRIBE
 OUTPATIENT CLINIC
 SEQUIM, WASHINGTON

FOR PLAN CHECK REVIEW

REV	DATE	DESCRIPTION

PROJ. NO. 191652
 DRAWN MPB
 CHECKED ALH
 DATE JAN 10, 2020

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SHEET TITLE:

CIRCULATION PLAN

SHEET NO:

C7.0

SHEET OF